1929_Eagle Mews - 150 Royal College Street

Design Access Statement - Planning Brochure - Vol 2 of 2



For Cumbrae Properties (1963) Ltd

Revision: - 14.05.21

Revision History

Title:	146-150 Royal College Street
	Design Access Statement
Filename:	P:1929-191202-DAS Brochure_LB01
Compiled by:	LB
Checked by:	PS
Status:	Issued
Revision:	-
Date:	14.05.21
History:	
-	14.05.21
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- 2.0 Context

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- 6.0 Landscape Design

- 7.0 Design Summary
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10.1 Drawing List

GLUCK	MANSMITH						
Drawing issue and r							
Ve enclose copies of the dra							
Project 1929_Royal Co	llege Street						
			Sheet No				[1]
			Issue No. Date of				
			issue	21119	070120	270121	140521
				5	020	570	140
Drawing No	Drawing Title	Size	Scale	Revisi			
Block Plan							
1929_X_0S_100	Site Location Plan	A1	1:500/1000	-		Α	В
1929_X_0S_100_002	Site Plan	A1	1:100	-			A
Plans Existing							
1929_X_00_100	Existing Ground Floor Plan	A1	1:50	-	Α	В	С
1929_X_00_101	Existing First Floor Plan	A1	1:50	-	А	В	С
1929_X_00_102	Existing Second Floor Plan	A1	1:50	-	Α	В	С
				-			
Elevations Existing		1	1.50				
1929_X_00_201	Existing Elevation 1 Royal College Street	A1	1:50		-	A	В
1929_X_00_202	Existing Elevation 2 Canal Elevation	A1	1:50	-	A	В	С
1929_X_00_203	Existing Elevation 3 Mews Elevation	A1	1:50			-	A
-							
Sections Existing							
1929_X_00_301	Existing Section A-A	A1	1:50			-	A
1929_X_00_302	Existing Section B-B	A1	1:50			-	A
Demolition			4.50				
1929_12_100	Existing Ground Floor Plan Demolition	A1	1:50			-	A
1929_12_101	Existing First Floor Plan Demolition	A1	1:50			-	A
1929_12_201	Existing Elevation 1 Royal College Street Demolition	A1 A1	1:50				A
1929_12_202	Existing Elevation 2 Canal Demolition	A1 A1	1:50			-	A
1929_12_203	Existing Elevation 3 Mews Demolition						
1929_12_301	Demolition Section AA Demolition Section BB	A1	1:50			-	A
1929_12_302	Demolition Section BB	A1	1:50			-	A
Plans Proposed		1.	-				
1929_00_001	Proposed Site Plan	A1	1:100				-
1929_00_100	Proposed Ground Floor Plan	A1	1:50			-	A
1929_00_101	Proposed First Floor Plan	A1	1:50			-	A
1929_00_102	Proposed Second Floor Plan	A1	1:50			-	A
1929_00_103	Proposed Third Floor Plan	A1	1:50			-	A
1929_00_104	Proposed Fourth / Roof Plan	A1	1:50	-		-	A
		1					
Elevations Proposed							
1929_00_200	Proposed Street Elevations	A1	1:50	A	В	С	D
1929_00_201	Royal College Street Elevation	A1	1:50			-	A
1929_00_201_002	Royal College Street Elevation	A1	1:50			-	A
1929_00_202	Regents Canal Elevation	A1	1:50			-	A
1929_00_203	Proposed Corner Elevation Royal College Street and Regents Canal	A1	1:50			-	A
1929_00_204	Proposed Elevation 4 Mews Elevation	A1	1:50			-	A
1929_00_205	Eagle Mews Section	A1	1:50				-


Facade Details Proposed								
1929_21_201_001	Proposed Elevation Building Bay 1	A1	1:50	A	В	С	D	
1929_21_201_001	Facade Detail Royal College Street Typical Ground Floor Windows	A1	1:20	~		-	A	
1929_21_201_002	Facade Detail Royal College Street Typical Windows	A1	1:20		-	A	В	
1929_21_201_003	Facade Detail Royal College Street Typical Windows	A1	1:20		-	A	B	
1929_21_201_004	Facade Detail Top Floor Typical Bay Windows	A1	1:20		-	A	B	
1929_21_202_001	Proposed Elevation Building Bay 2	A1	1:50	А	В	C	D	
1929_21_202_001	Facade Detail Canal Side Typical Ground Floor Windows	A1	1:20	~	-	A	B	
1929_21_202_002	Façade Detail Regents Canal Typical Windows	A1	1:20			-	A	
1020_21_202_000	·							
Landscape Plan								
1929 L 00 100	Proposed Landscape Plan	A1	1:50			-	А	
1020_2_00_100								
List of Illustrations								
	Existing Royal College Street Elevation						-	
	Existing Regents Canal Elevation						-	
	Existing Mews Elevation						-	
	Proposed Ground Floor Plan						-	-
	Proposed First Floor Plan						-	
	Proposed Second Floor Plan						-	
	Proposed Third Floor Plan						-	
	Proposed Roof Plan						-	
	Proposed Royal College Street Elevation						-	
	Proposed Regents Canal Elevation						-	
	Proposed Corner Elevation Between RCS and RC						-	
	Proposed Eagle Mews Elevation						-	
	Proposed Elevation Building Bay 1						-	
	Facade Detail Royal College Street Typical Ground Floor						-	
	Facade Detail Royal College Street Typical Windows						-	
	Facade Detail Royal College Street Typical Windows						-	
	Facade Detail Top Floor Typical Bay Windows						-	
	Proposed Elevation Building Bay 2						-	
	Facade Detail Regents Canal Typical Ground Floor Windows						-	
	Facade Detail Regents Canal Typical Windows						-	
	Proposed Perspective Looking North on Royal College Street						-	
	Proposed Perspective Looking South on Royal College Street						-	
	Proposed Perspective Looking West on Regents Canal						-	
	Proposed Perspective Looking To Mews Entrance From RCS						-	
Distribution (see key below)		1						
Company			Contact Name					
Client								
Local Authority				х		х	х	
Structural Engineer								
Party Wall Surveyor	,							
Approved Building	Control Inspector							
Quantity Surveyor								
Contractor								
File								
Issued by								
	Purpose of issue							
	Preliminary							
	Planning			х		х	х	
	Tender							
	Contract							
	Construction							
	Information							


10.2 Existing Drawings, Plans and Elevations


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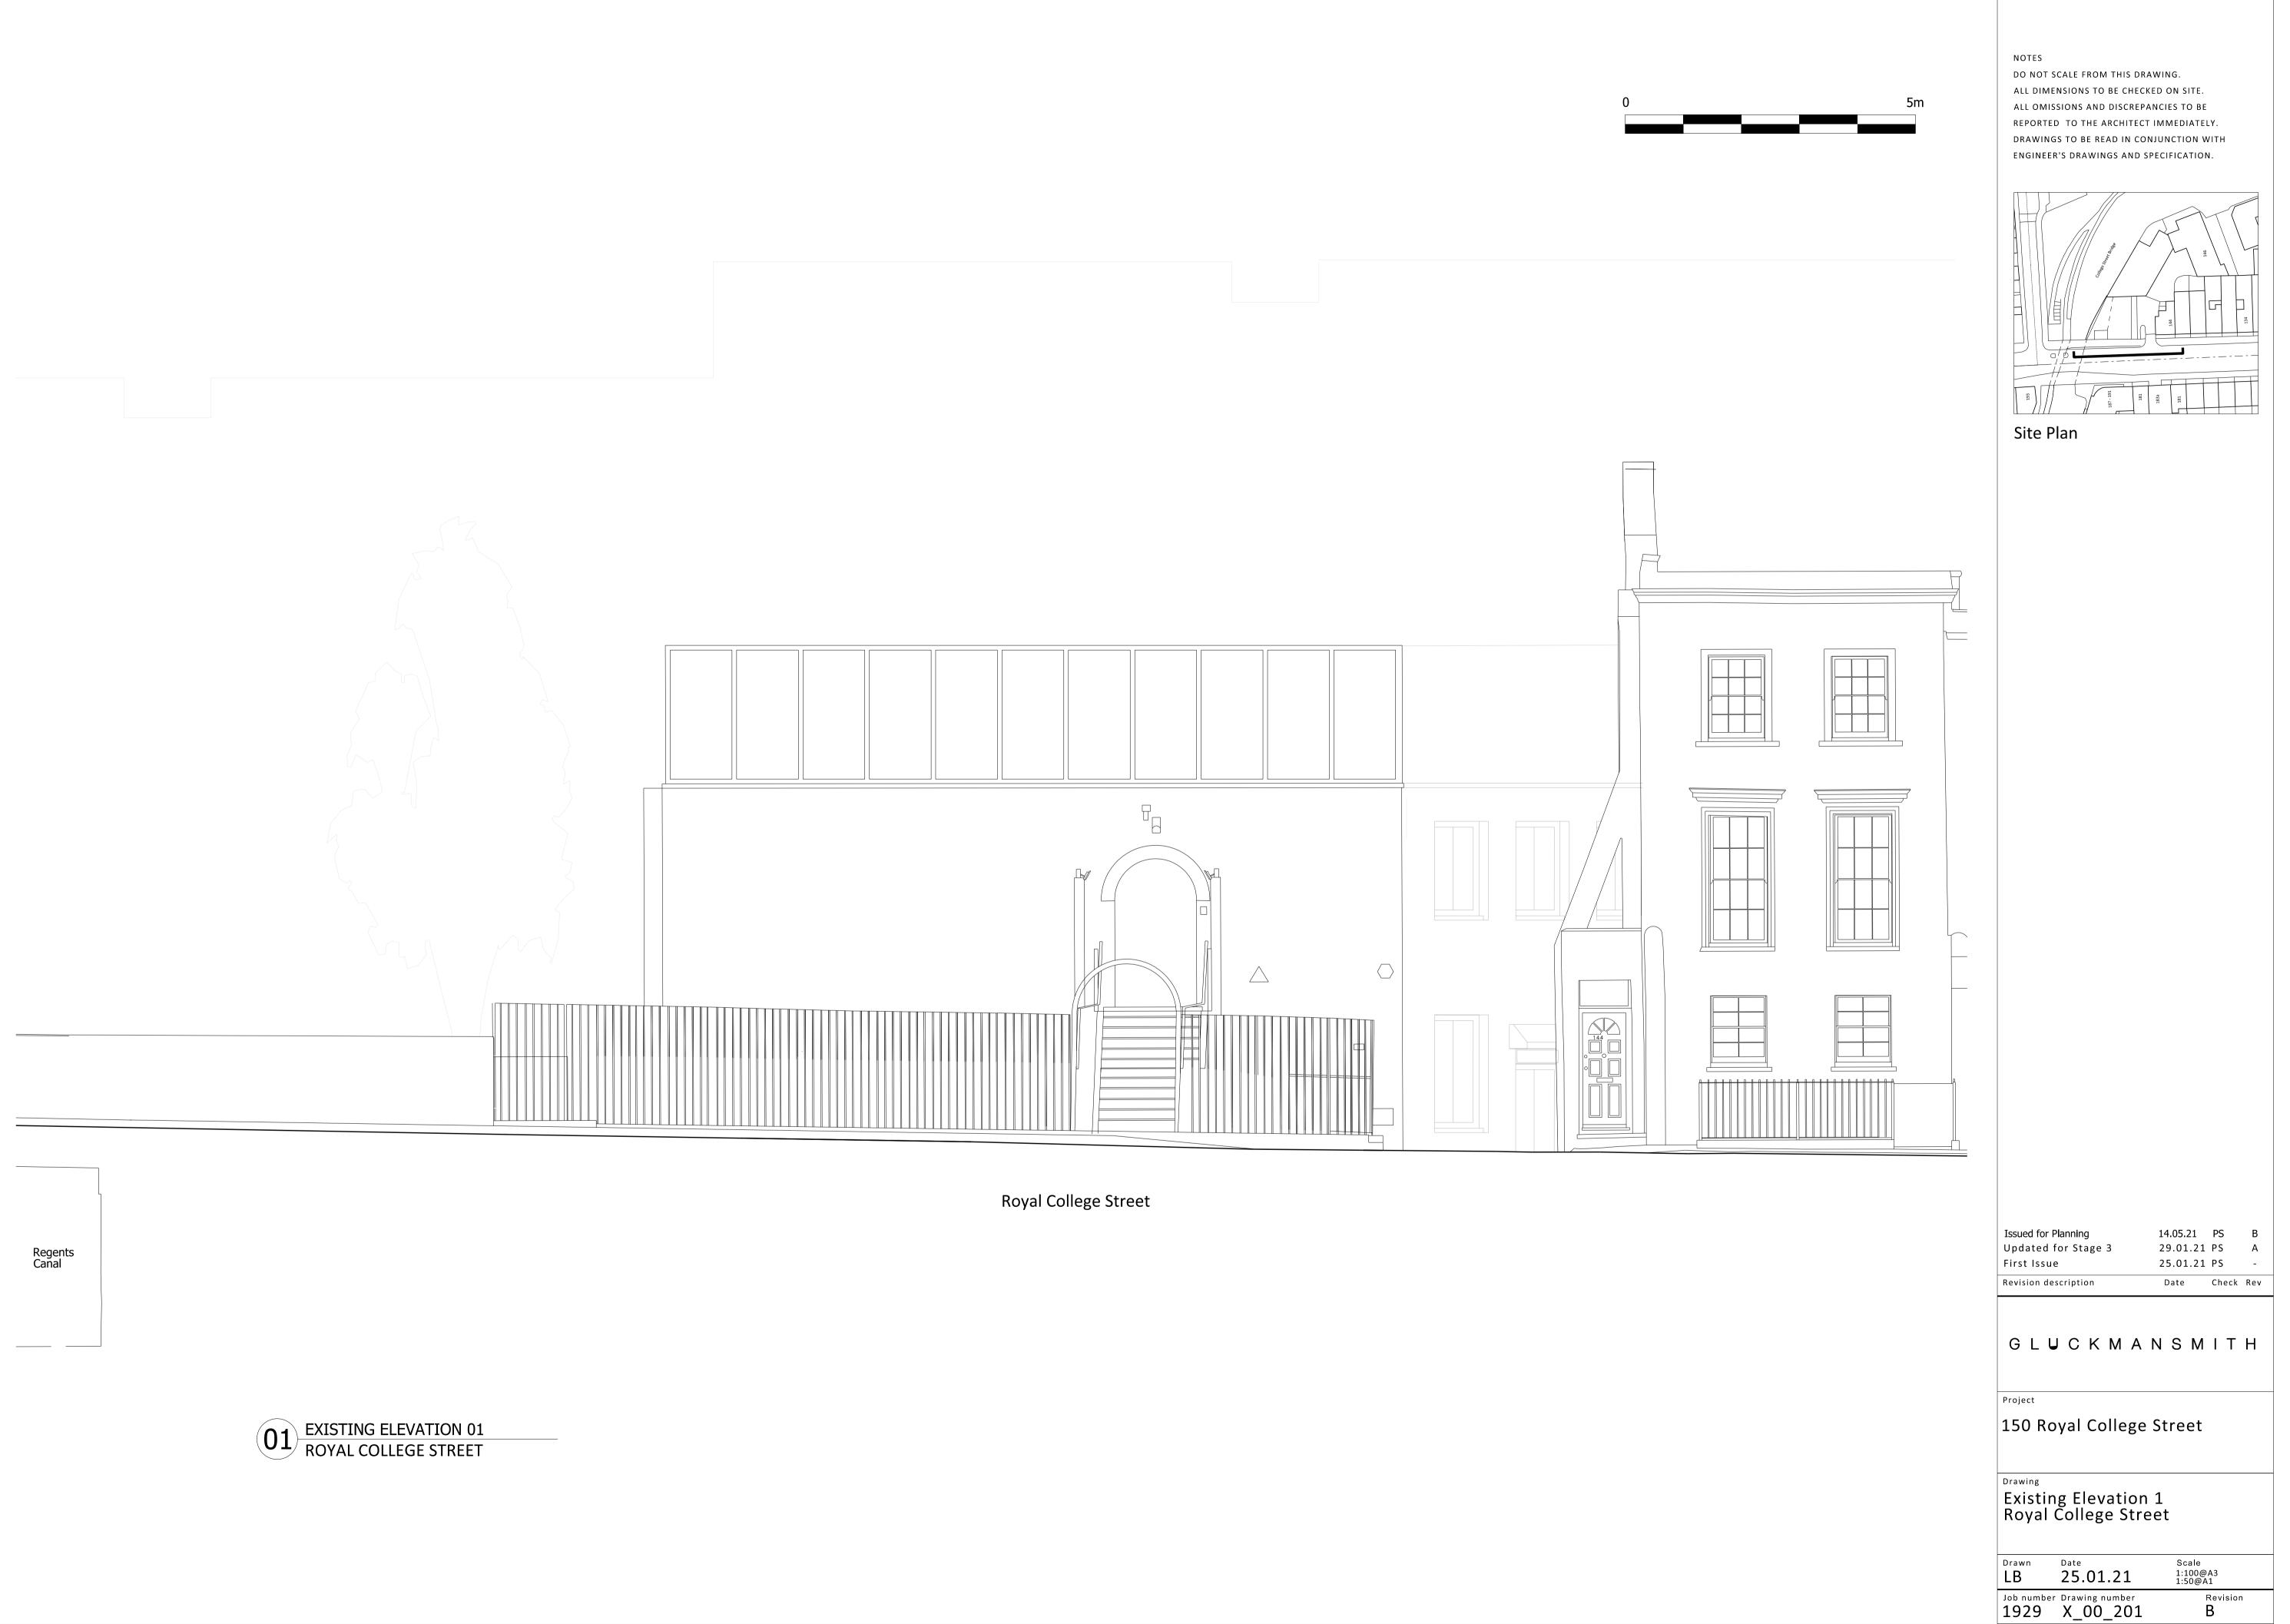







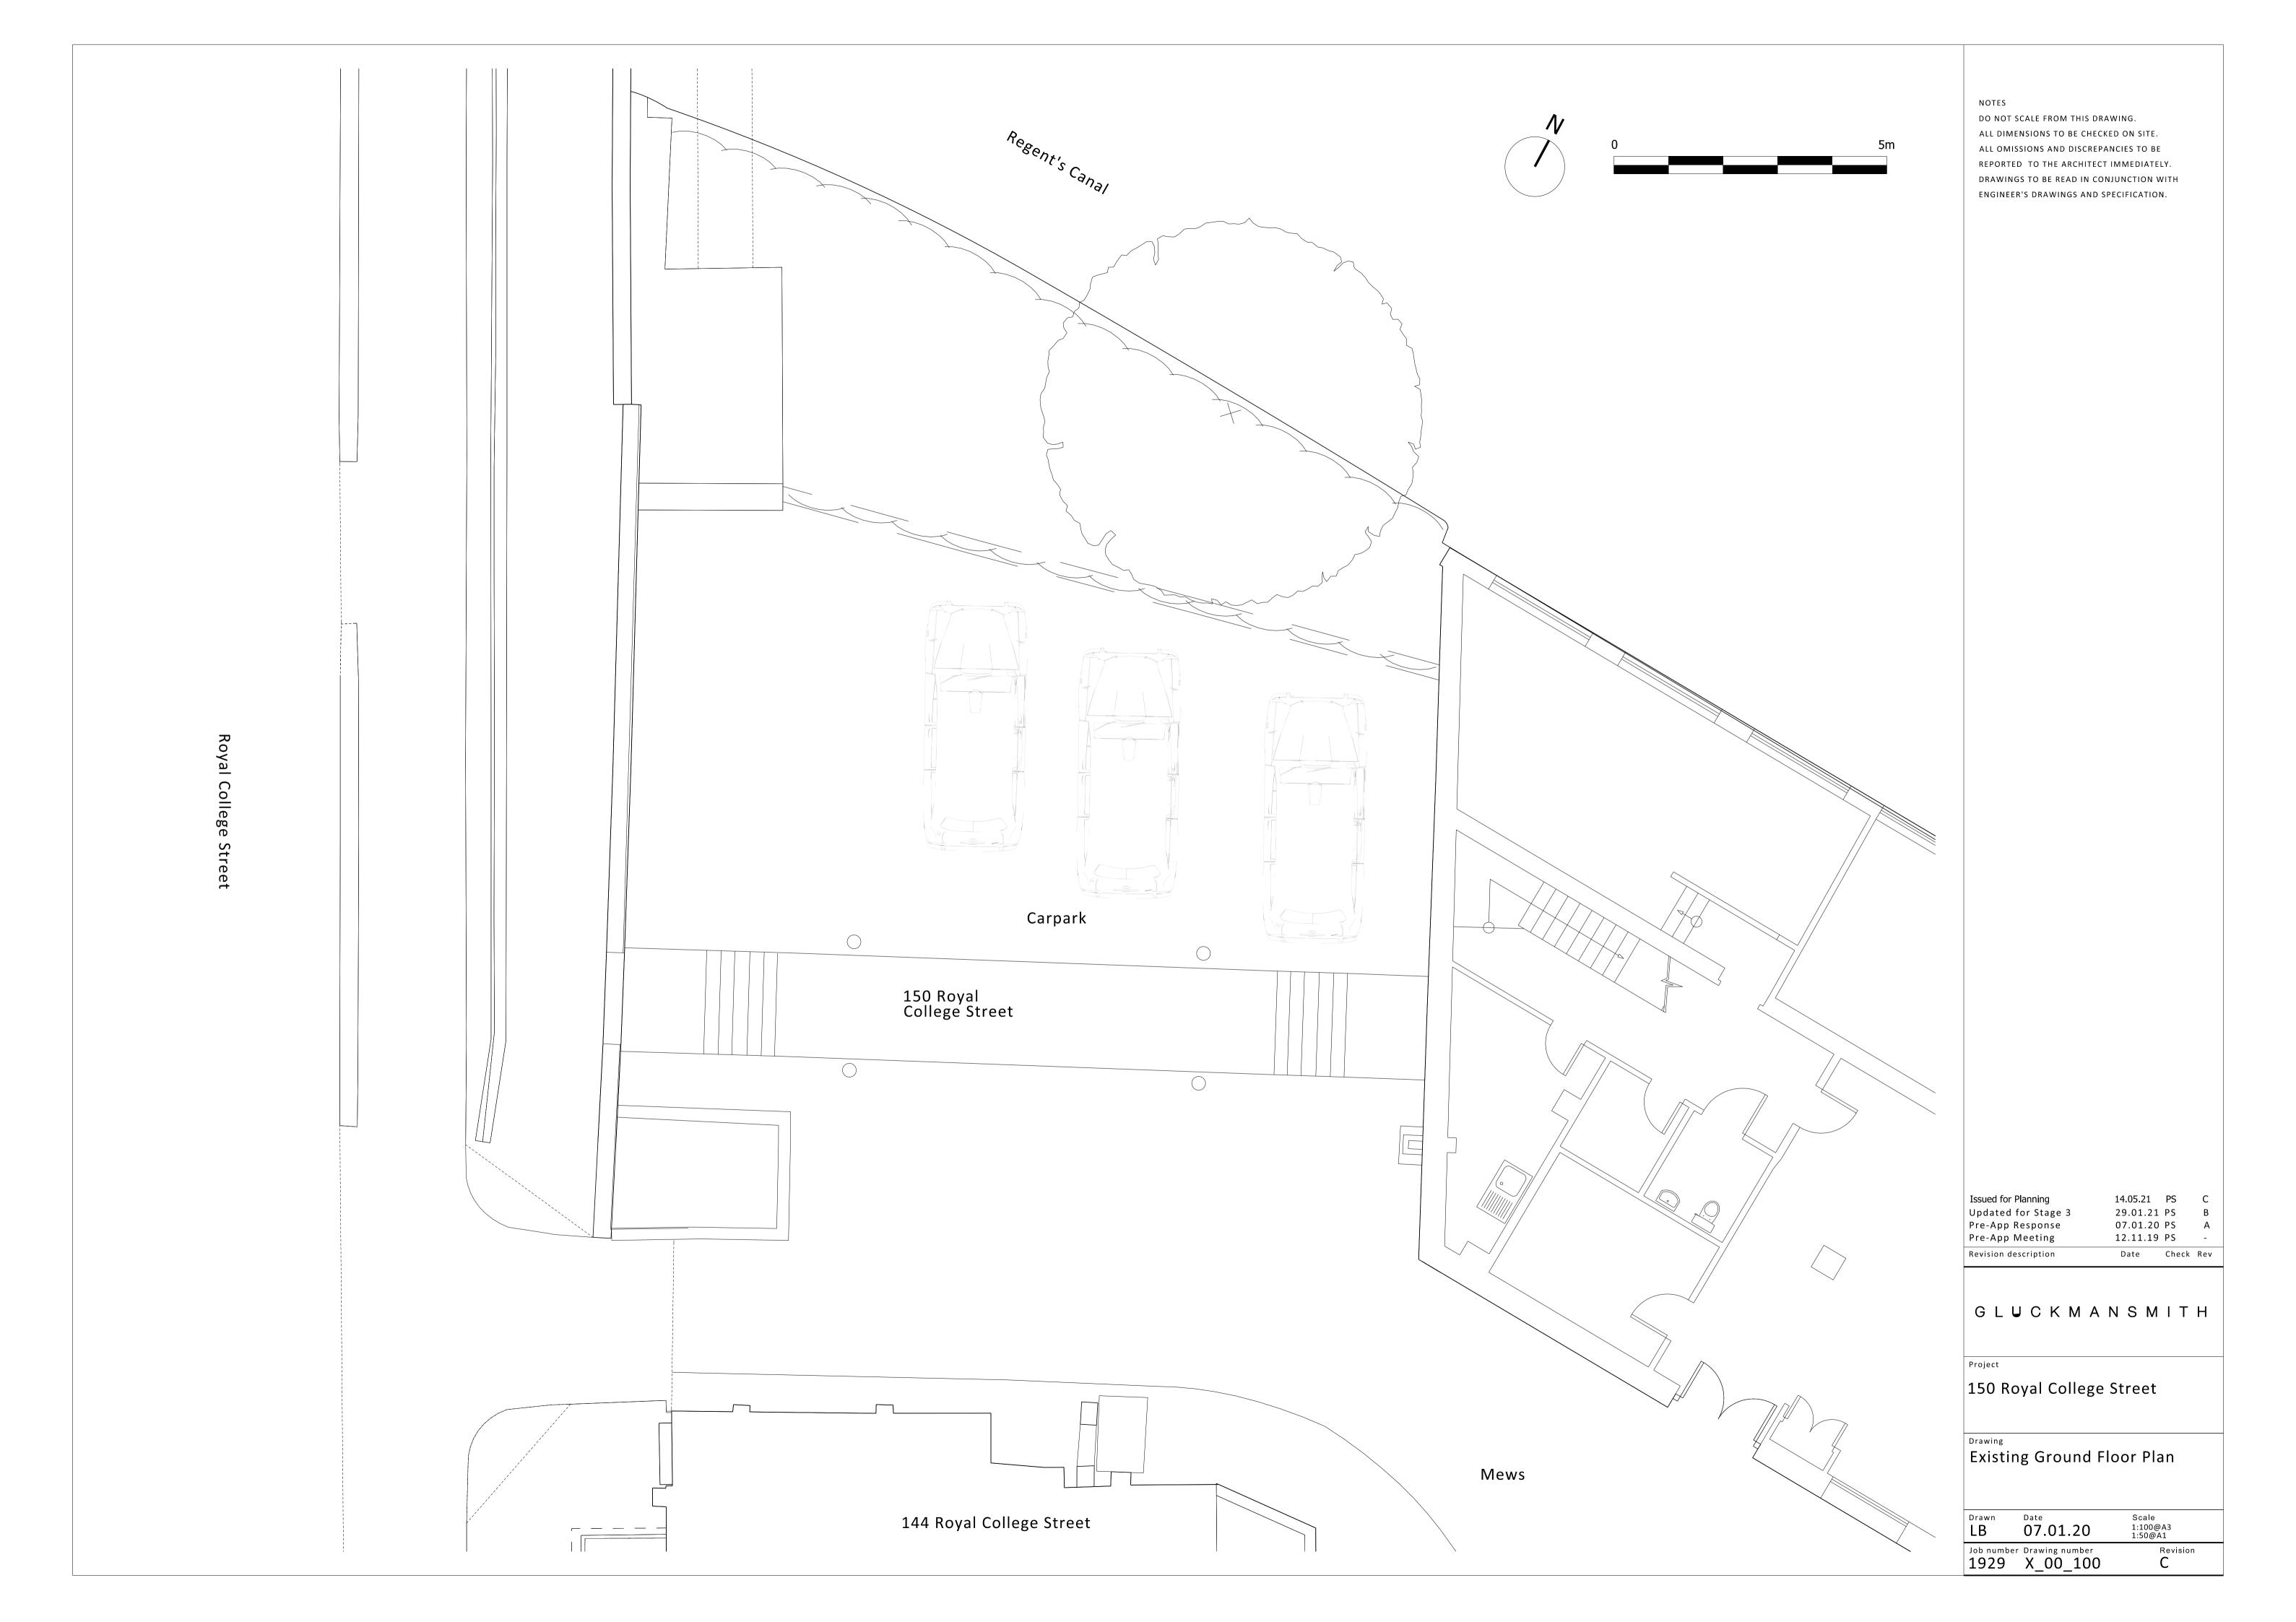


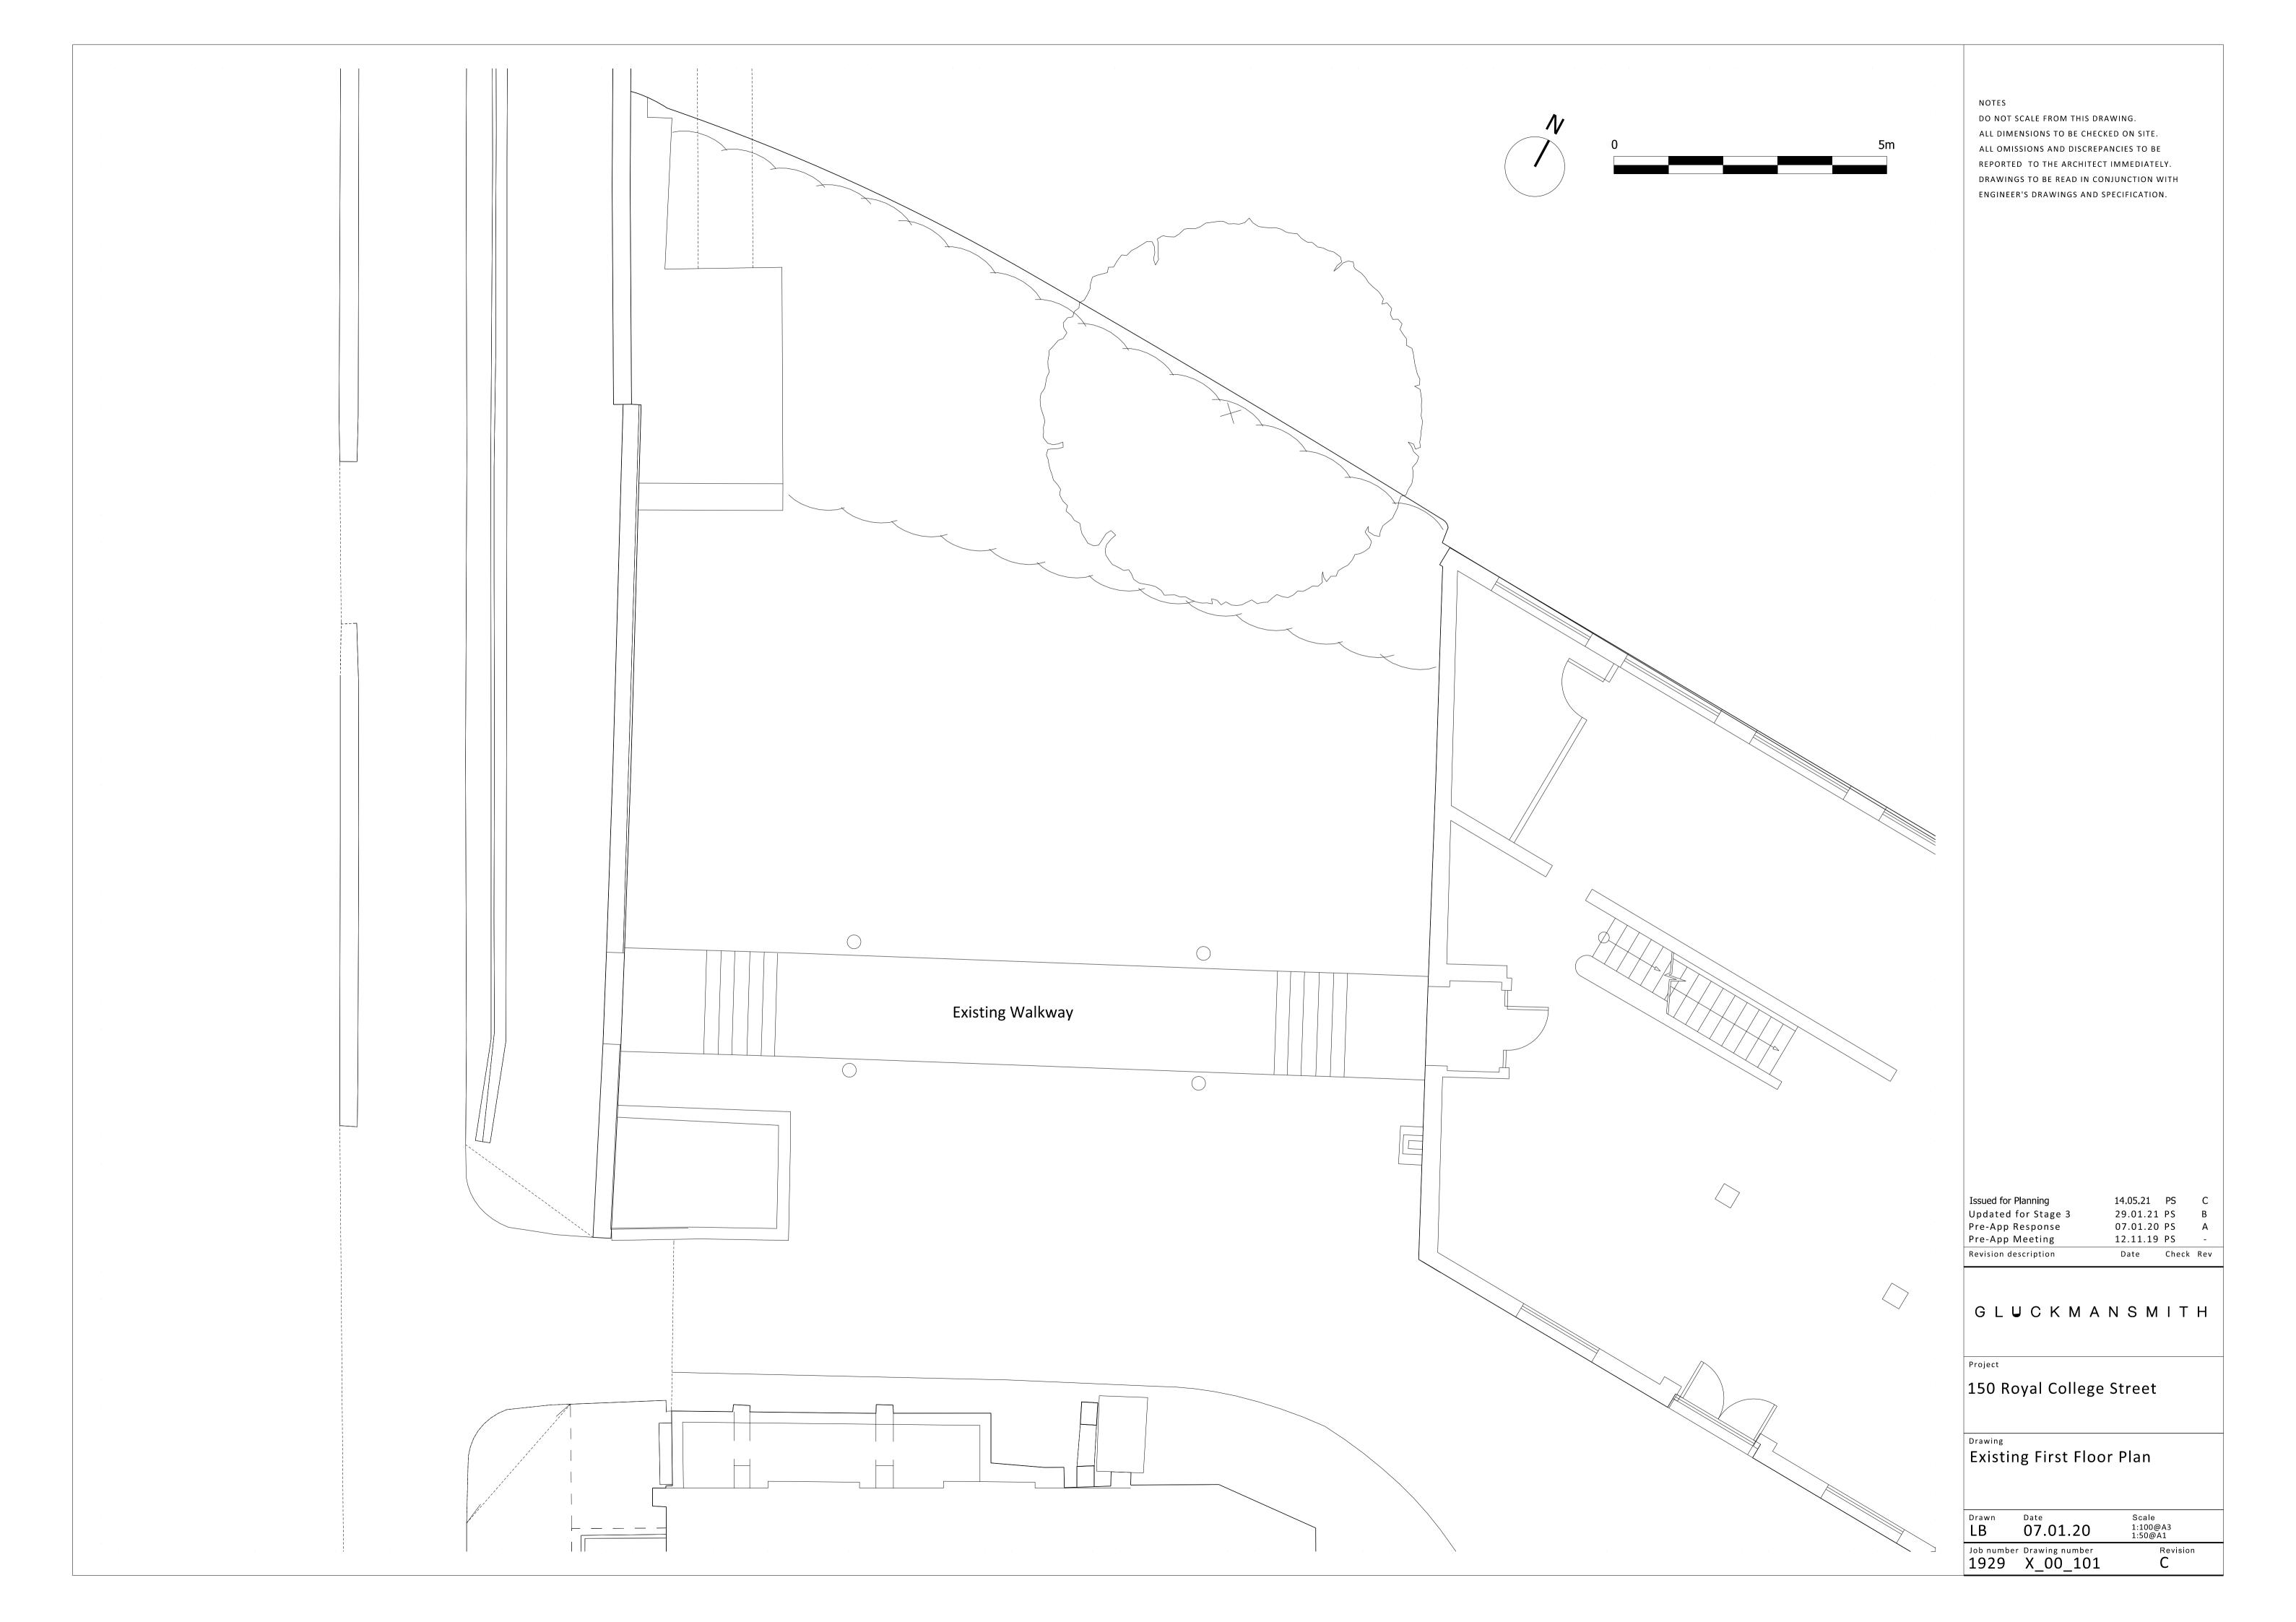

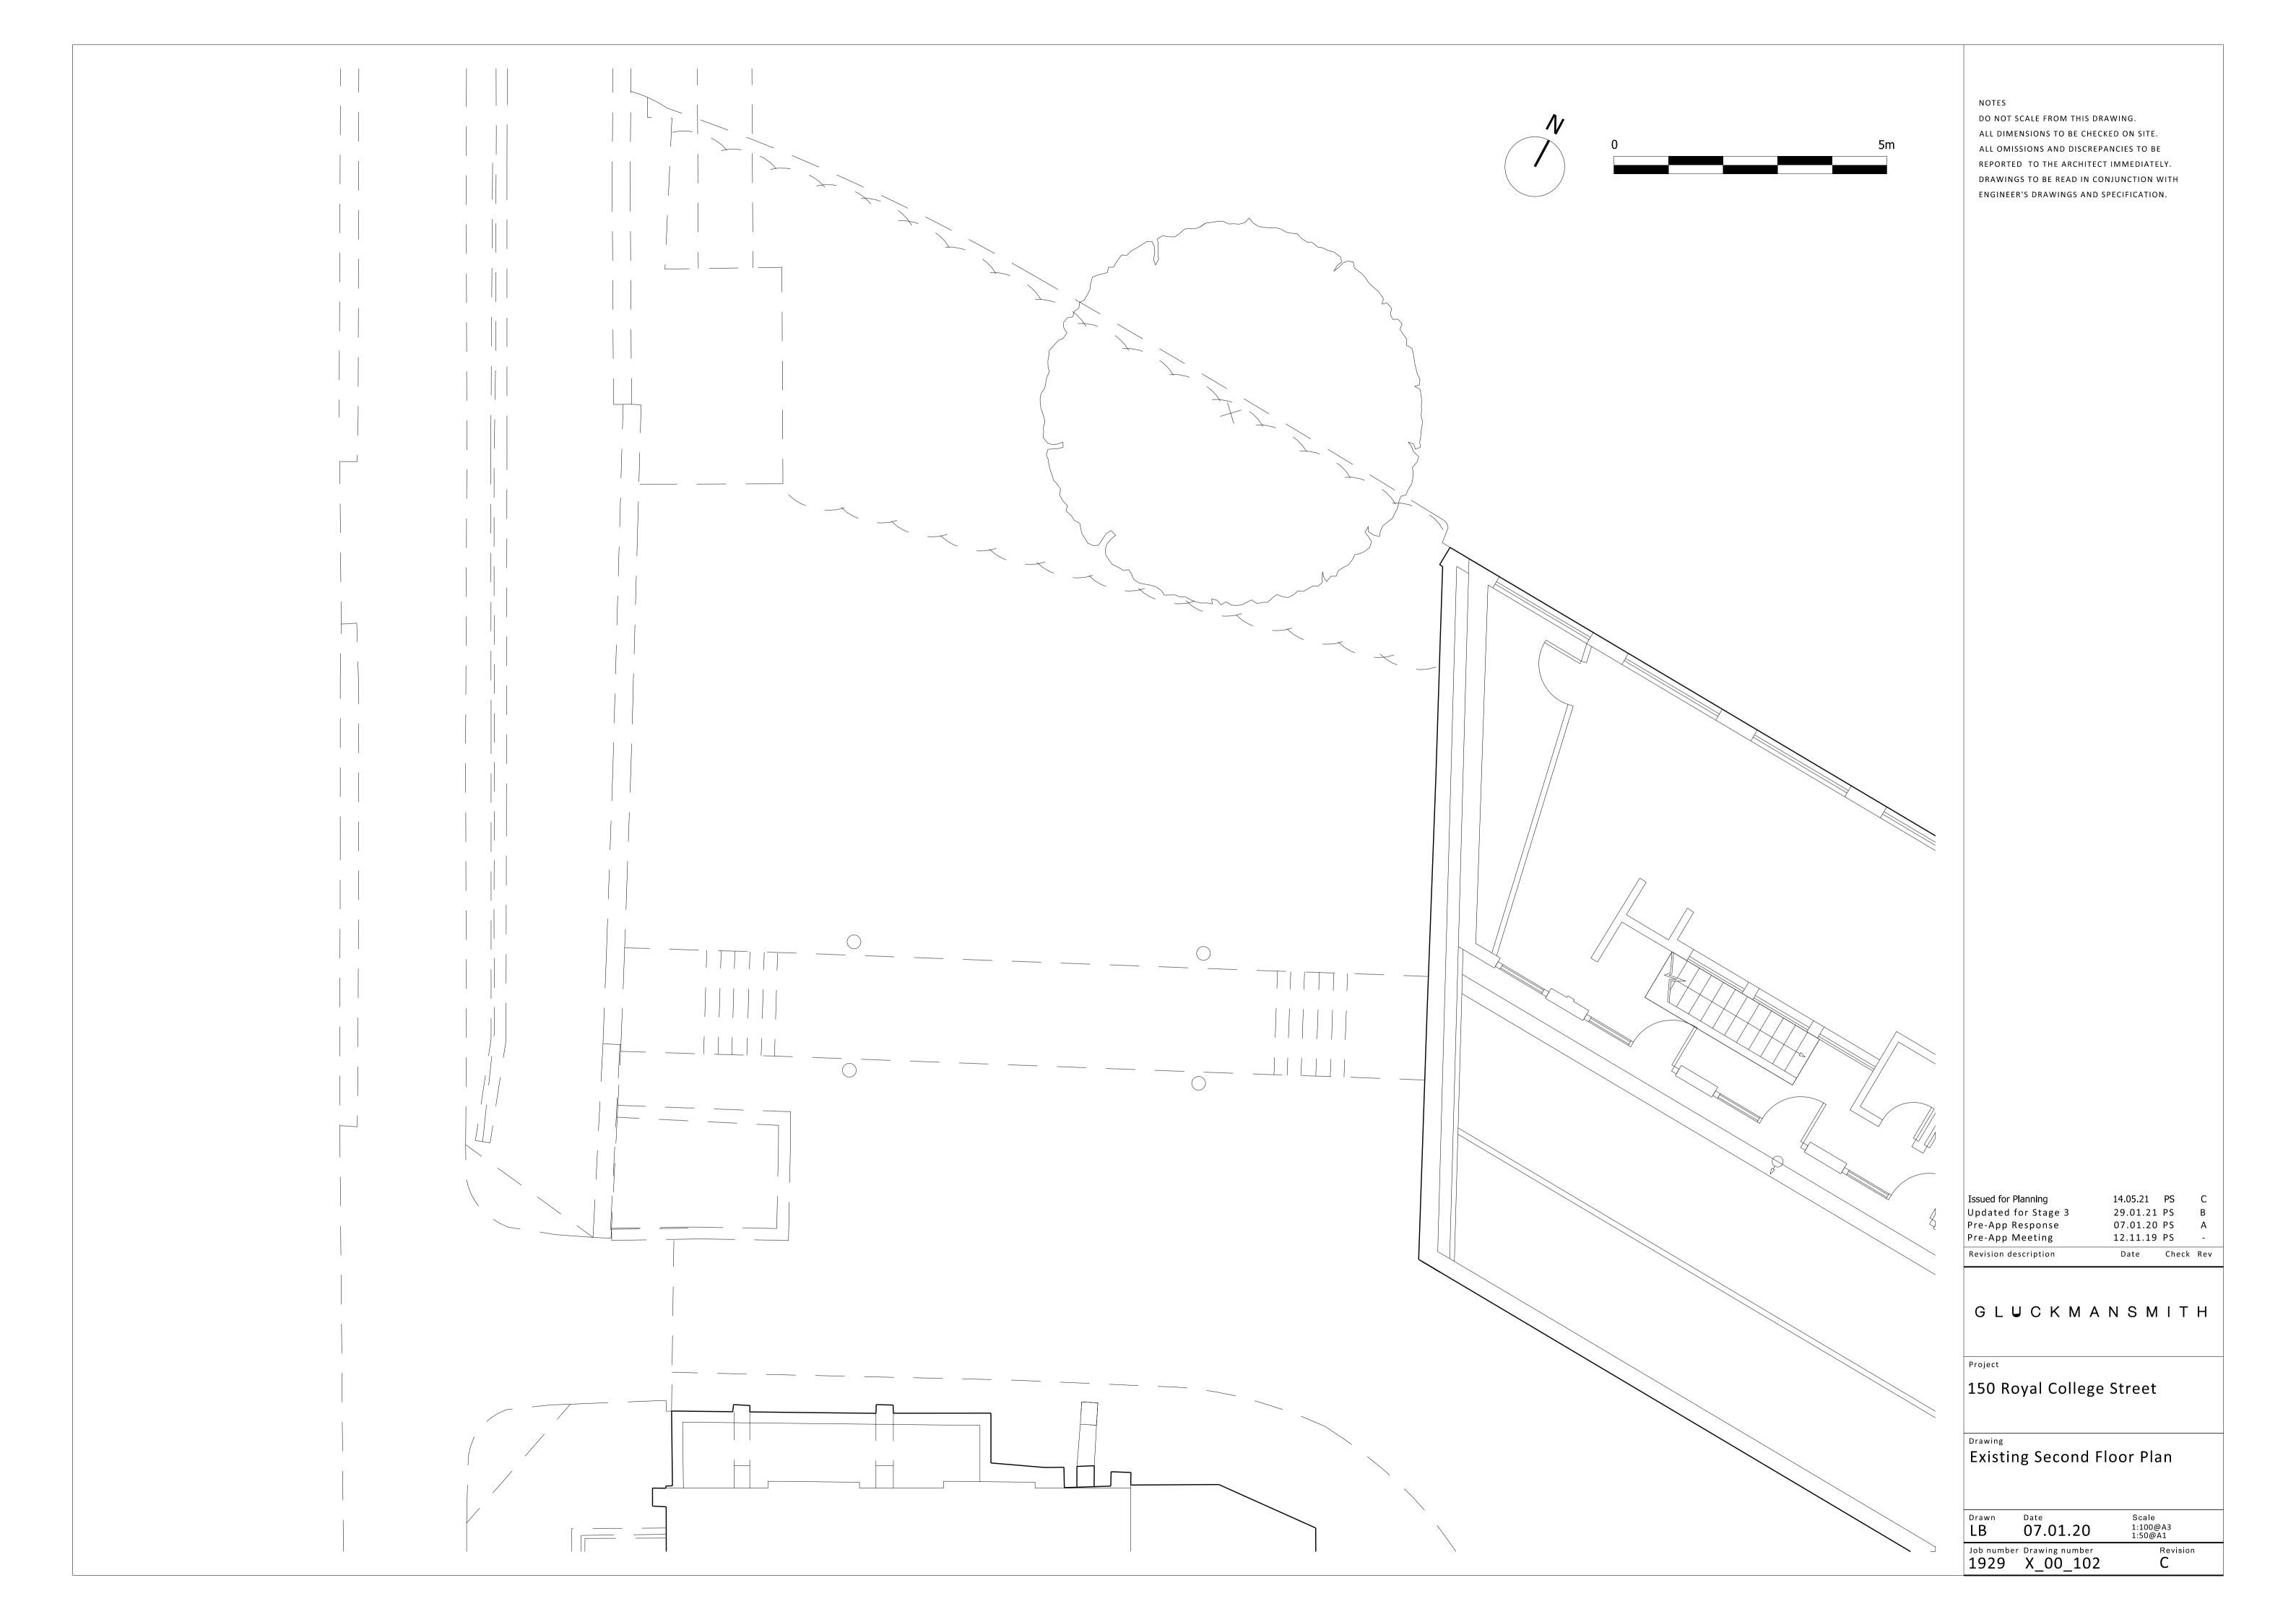



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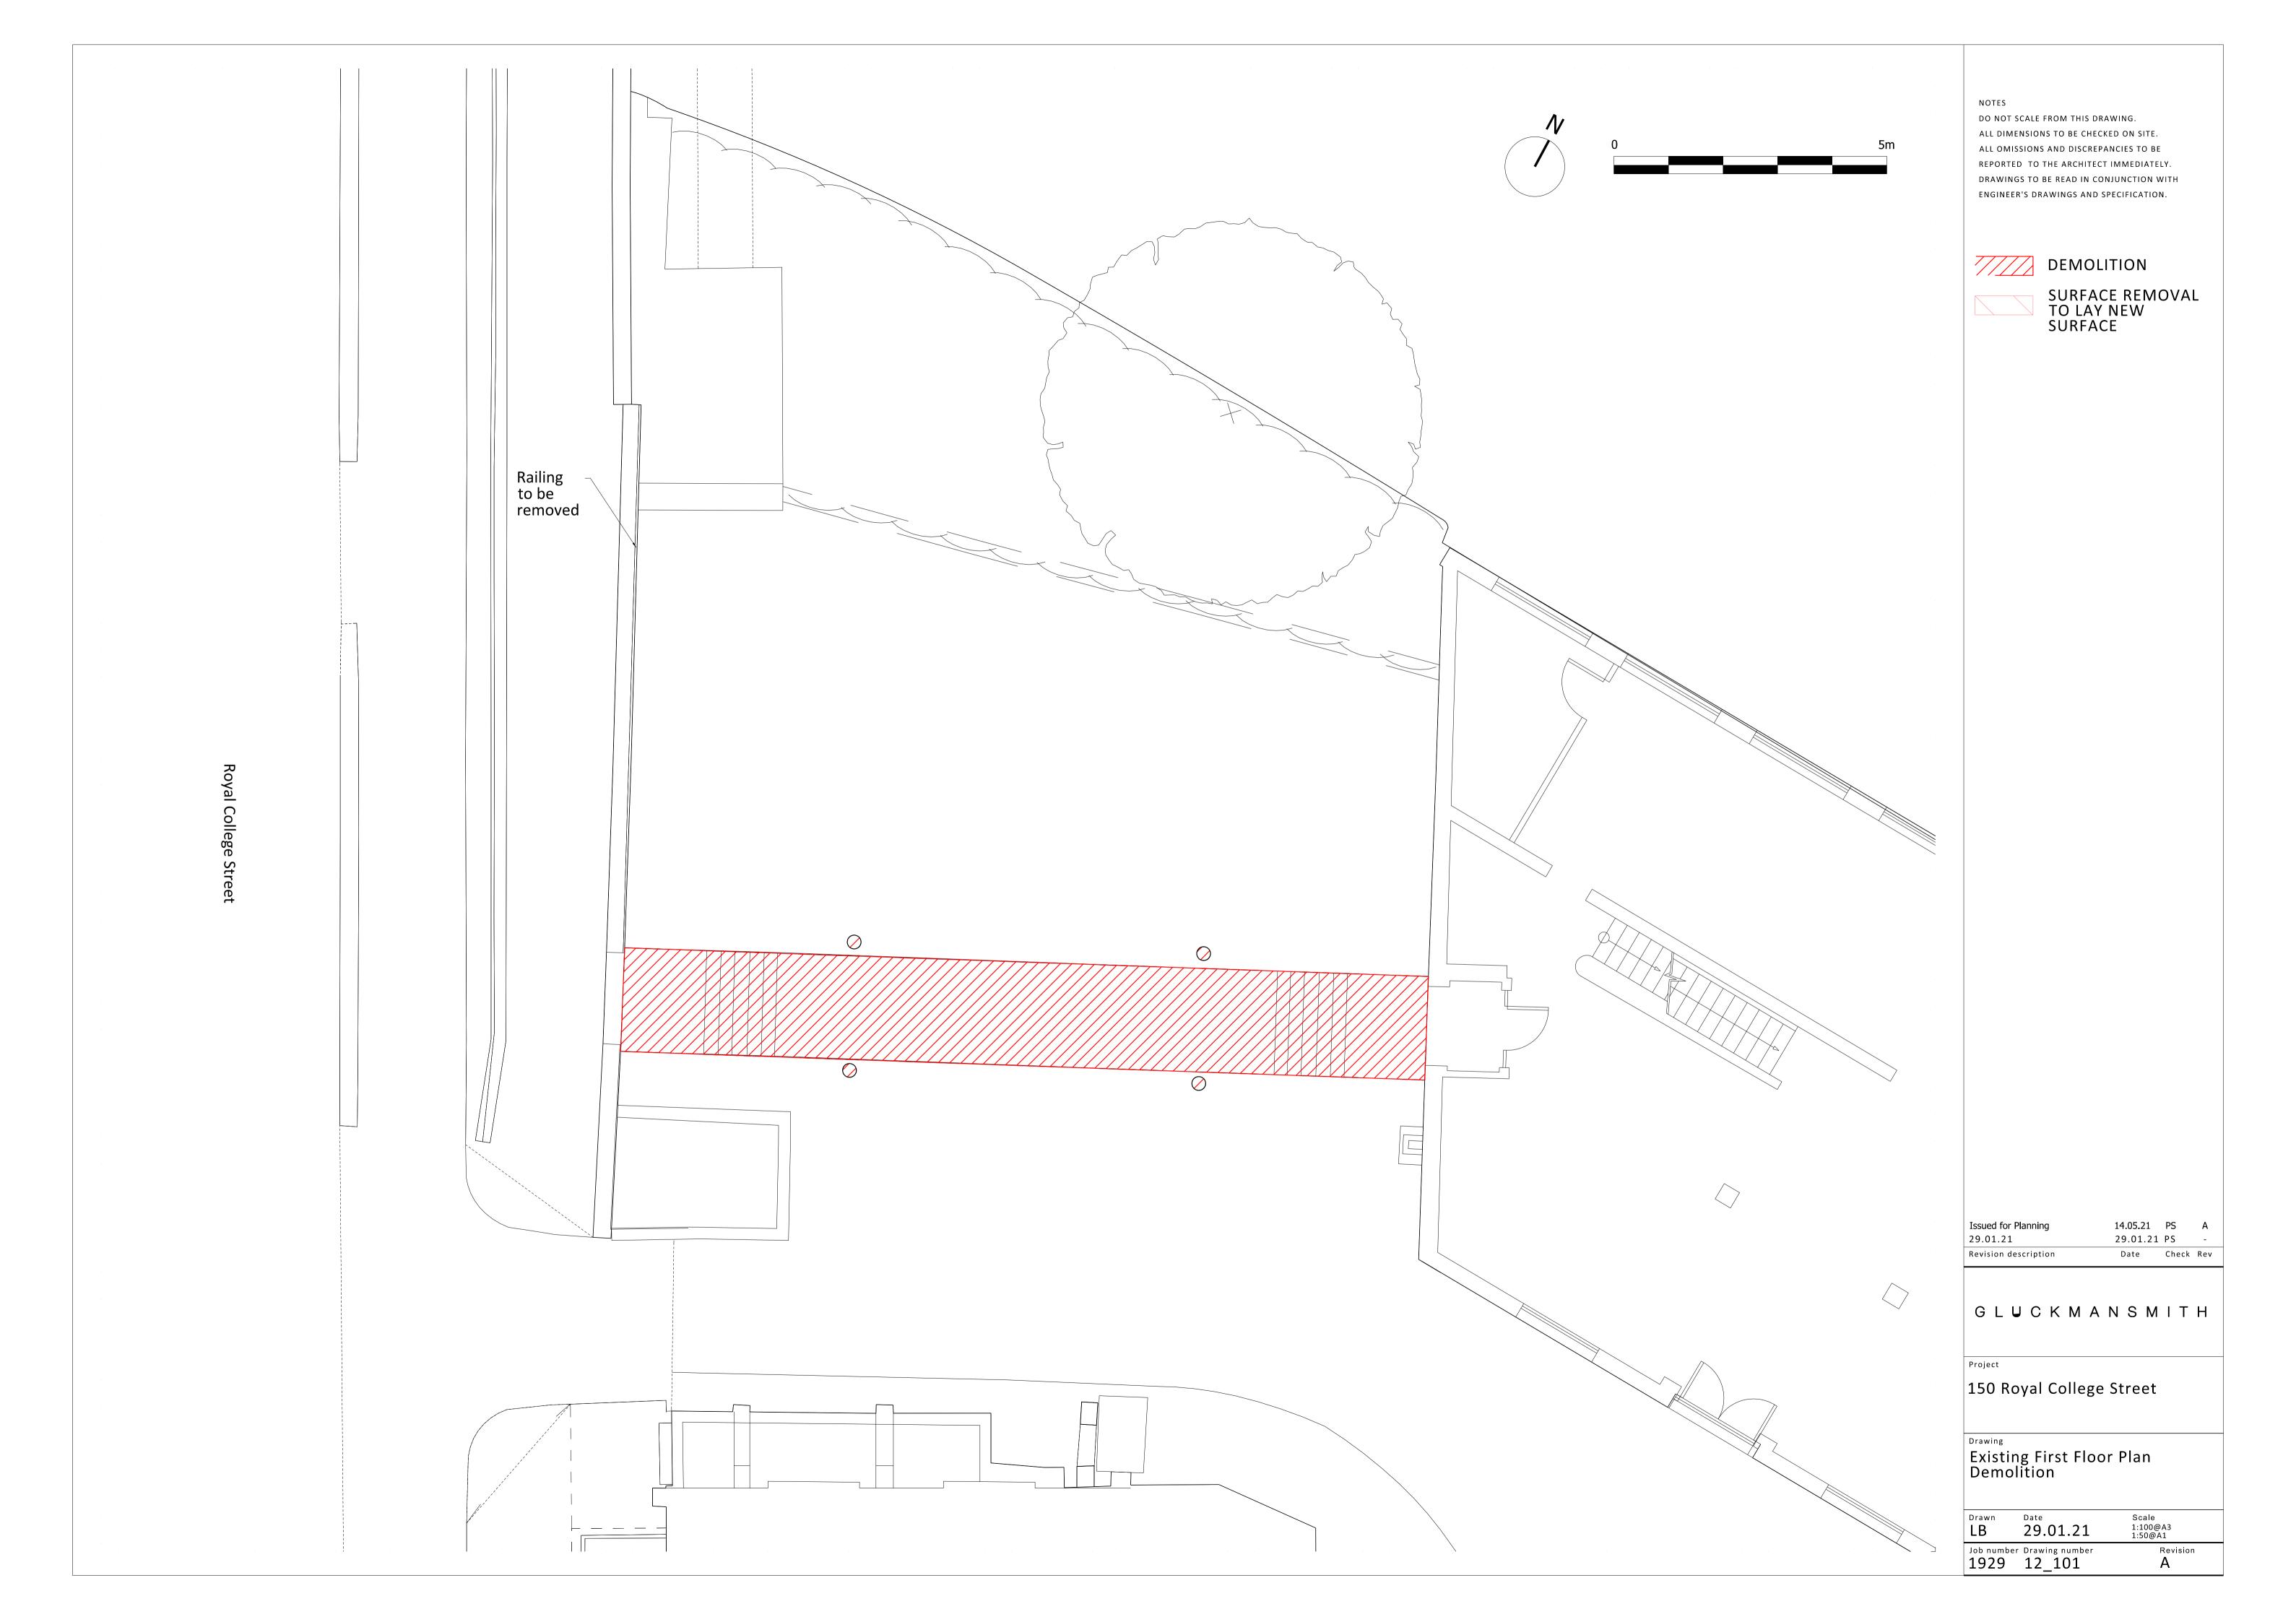


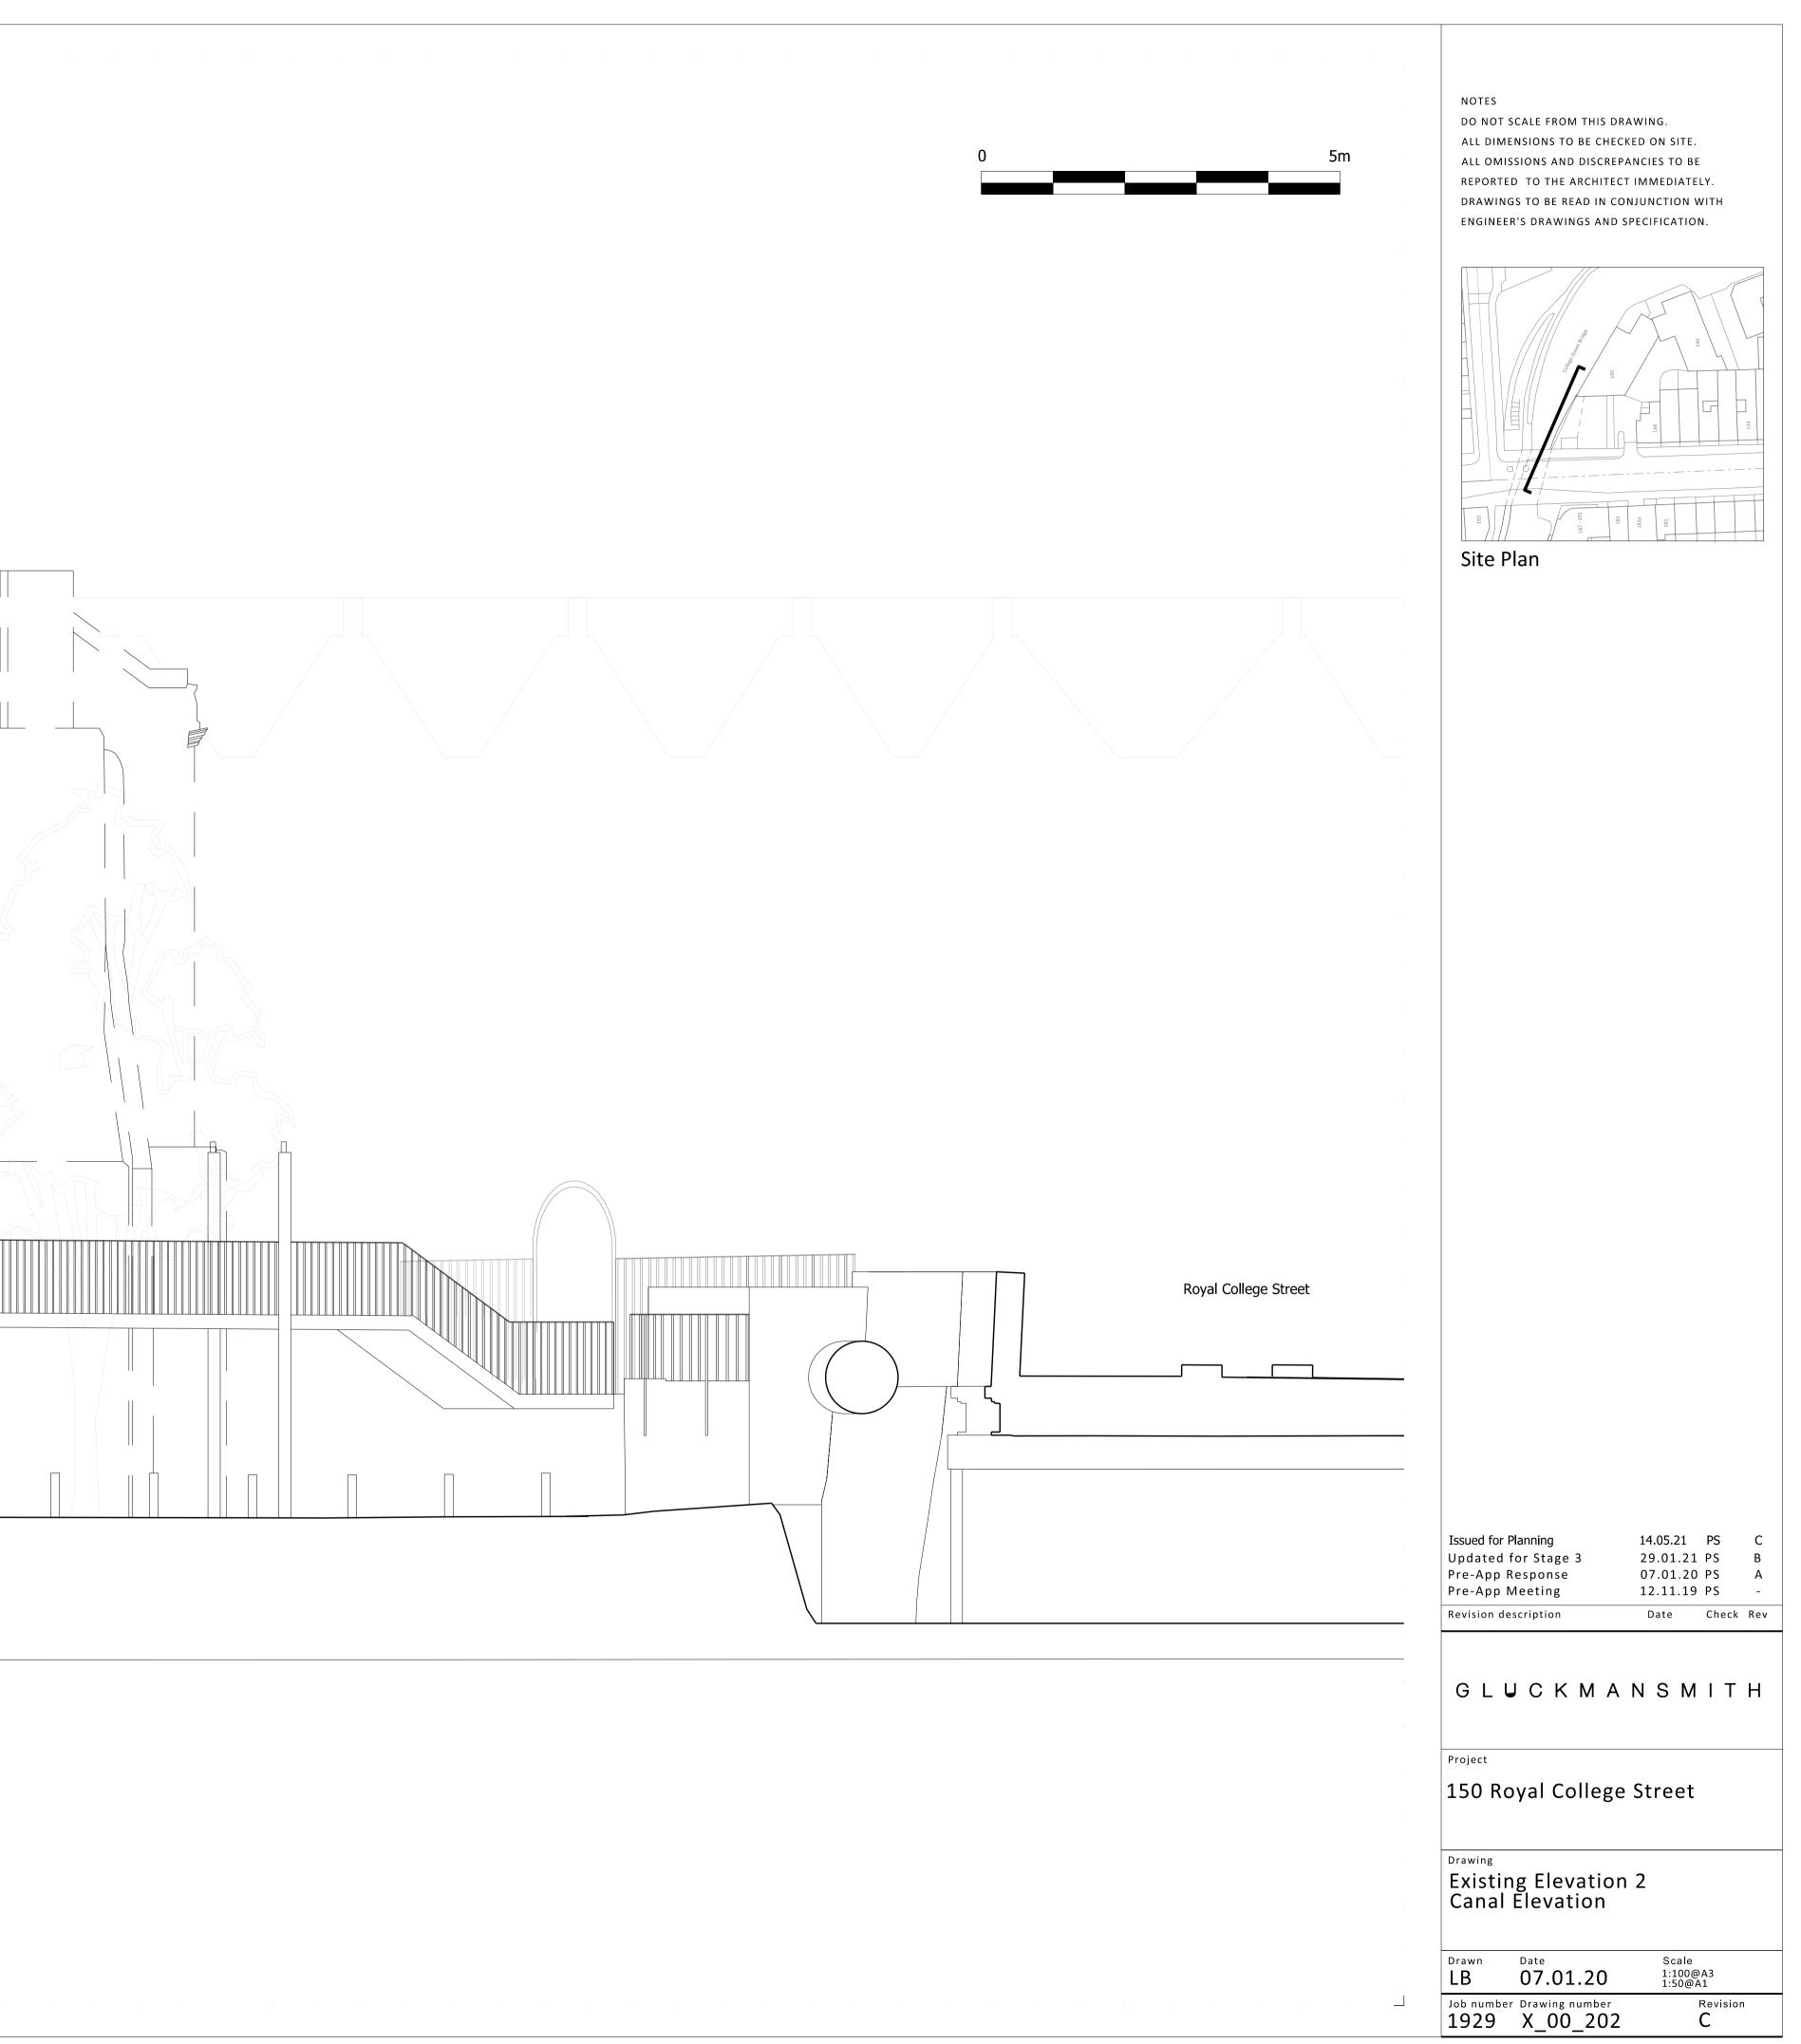
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10.3 Demolition Drawings, Plans and Elevations

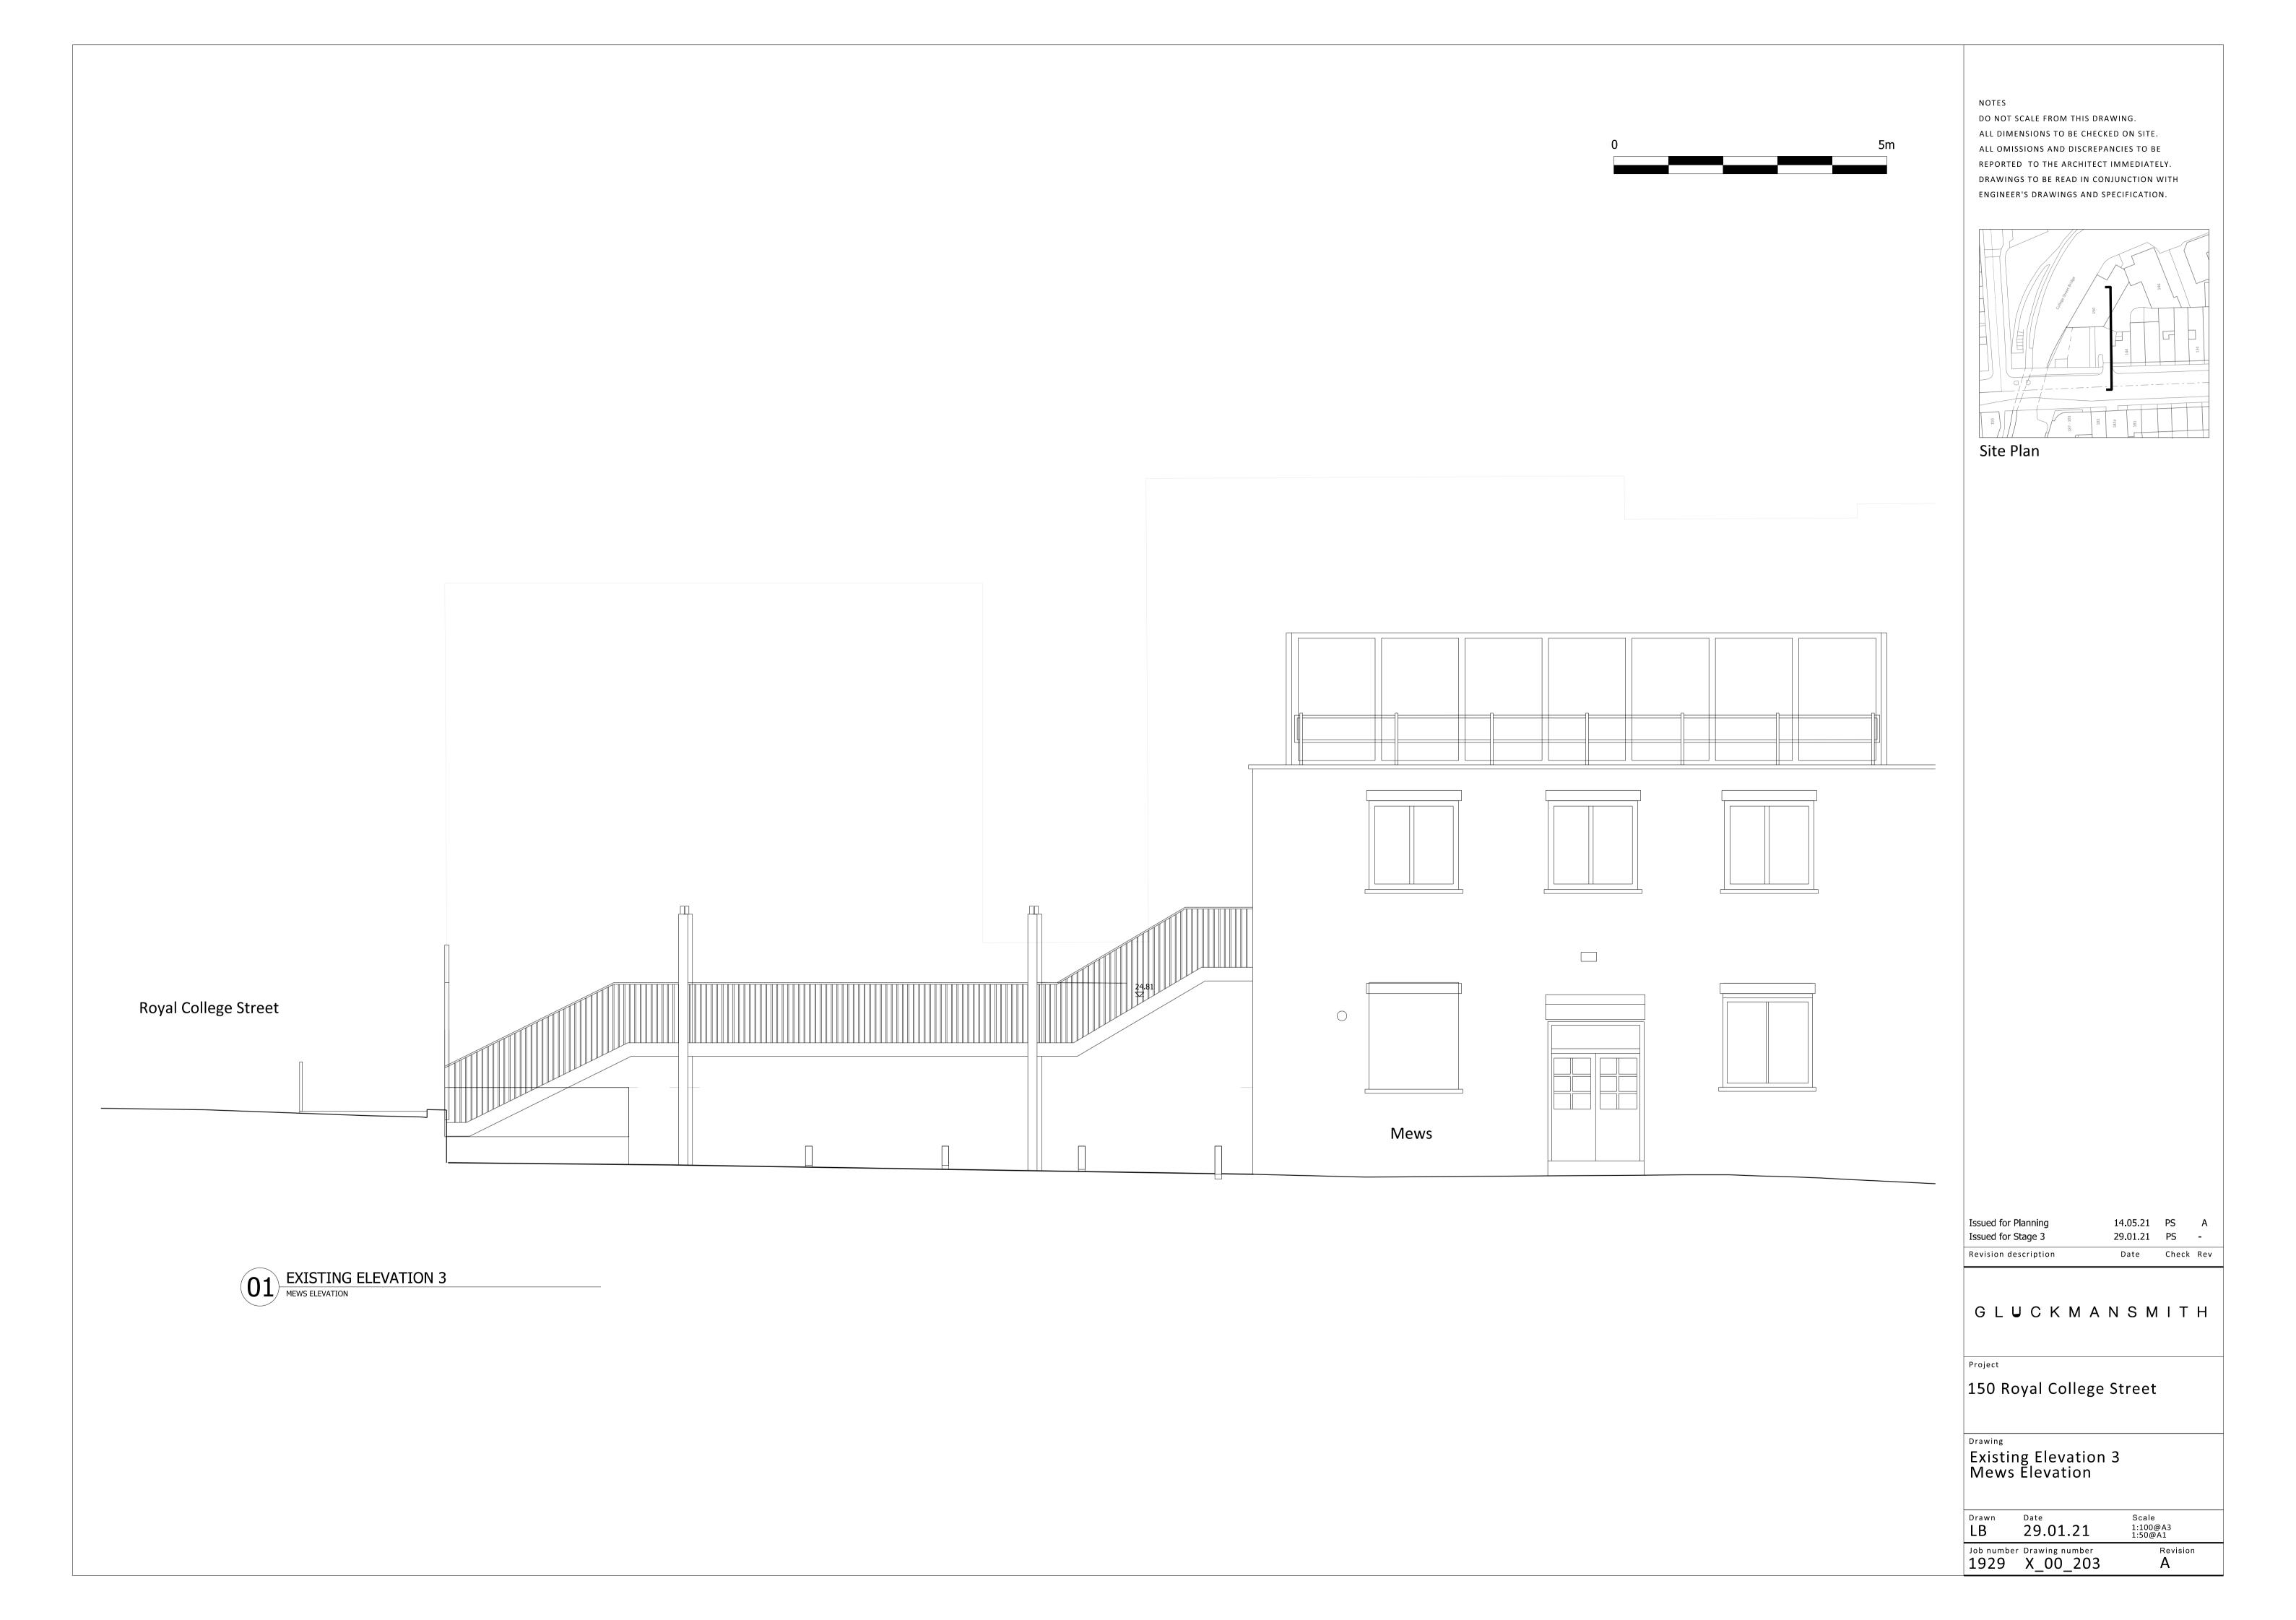
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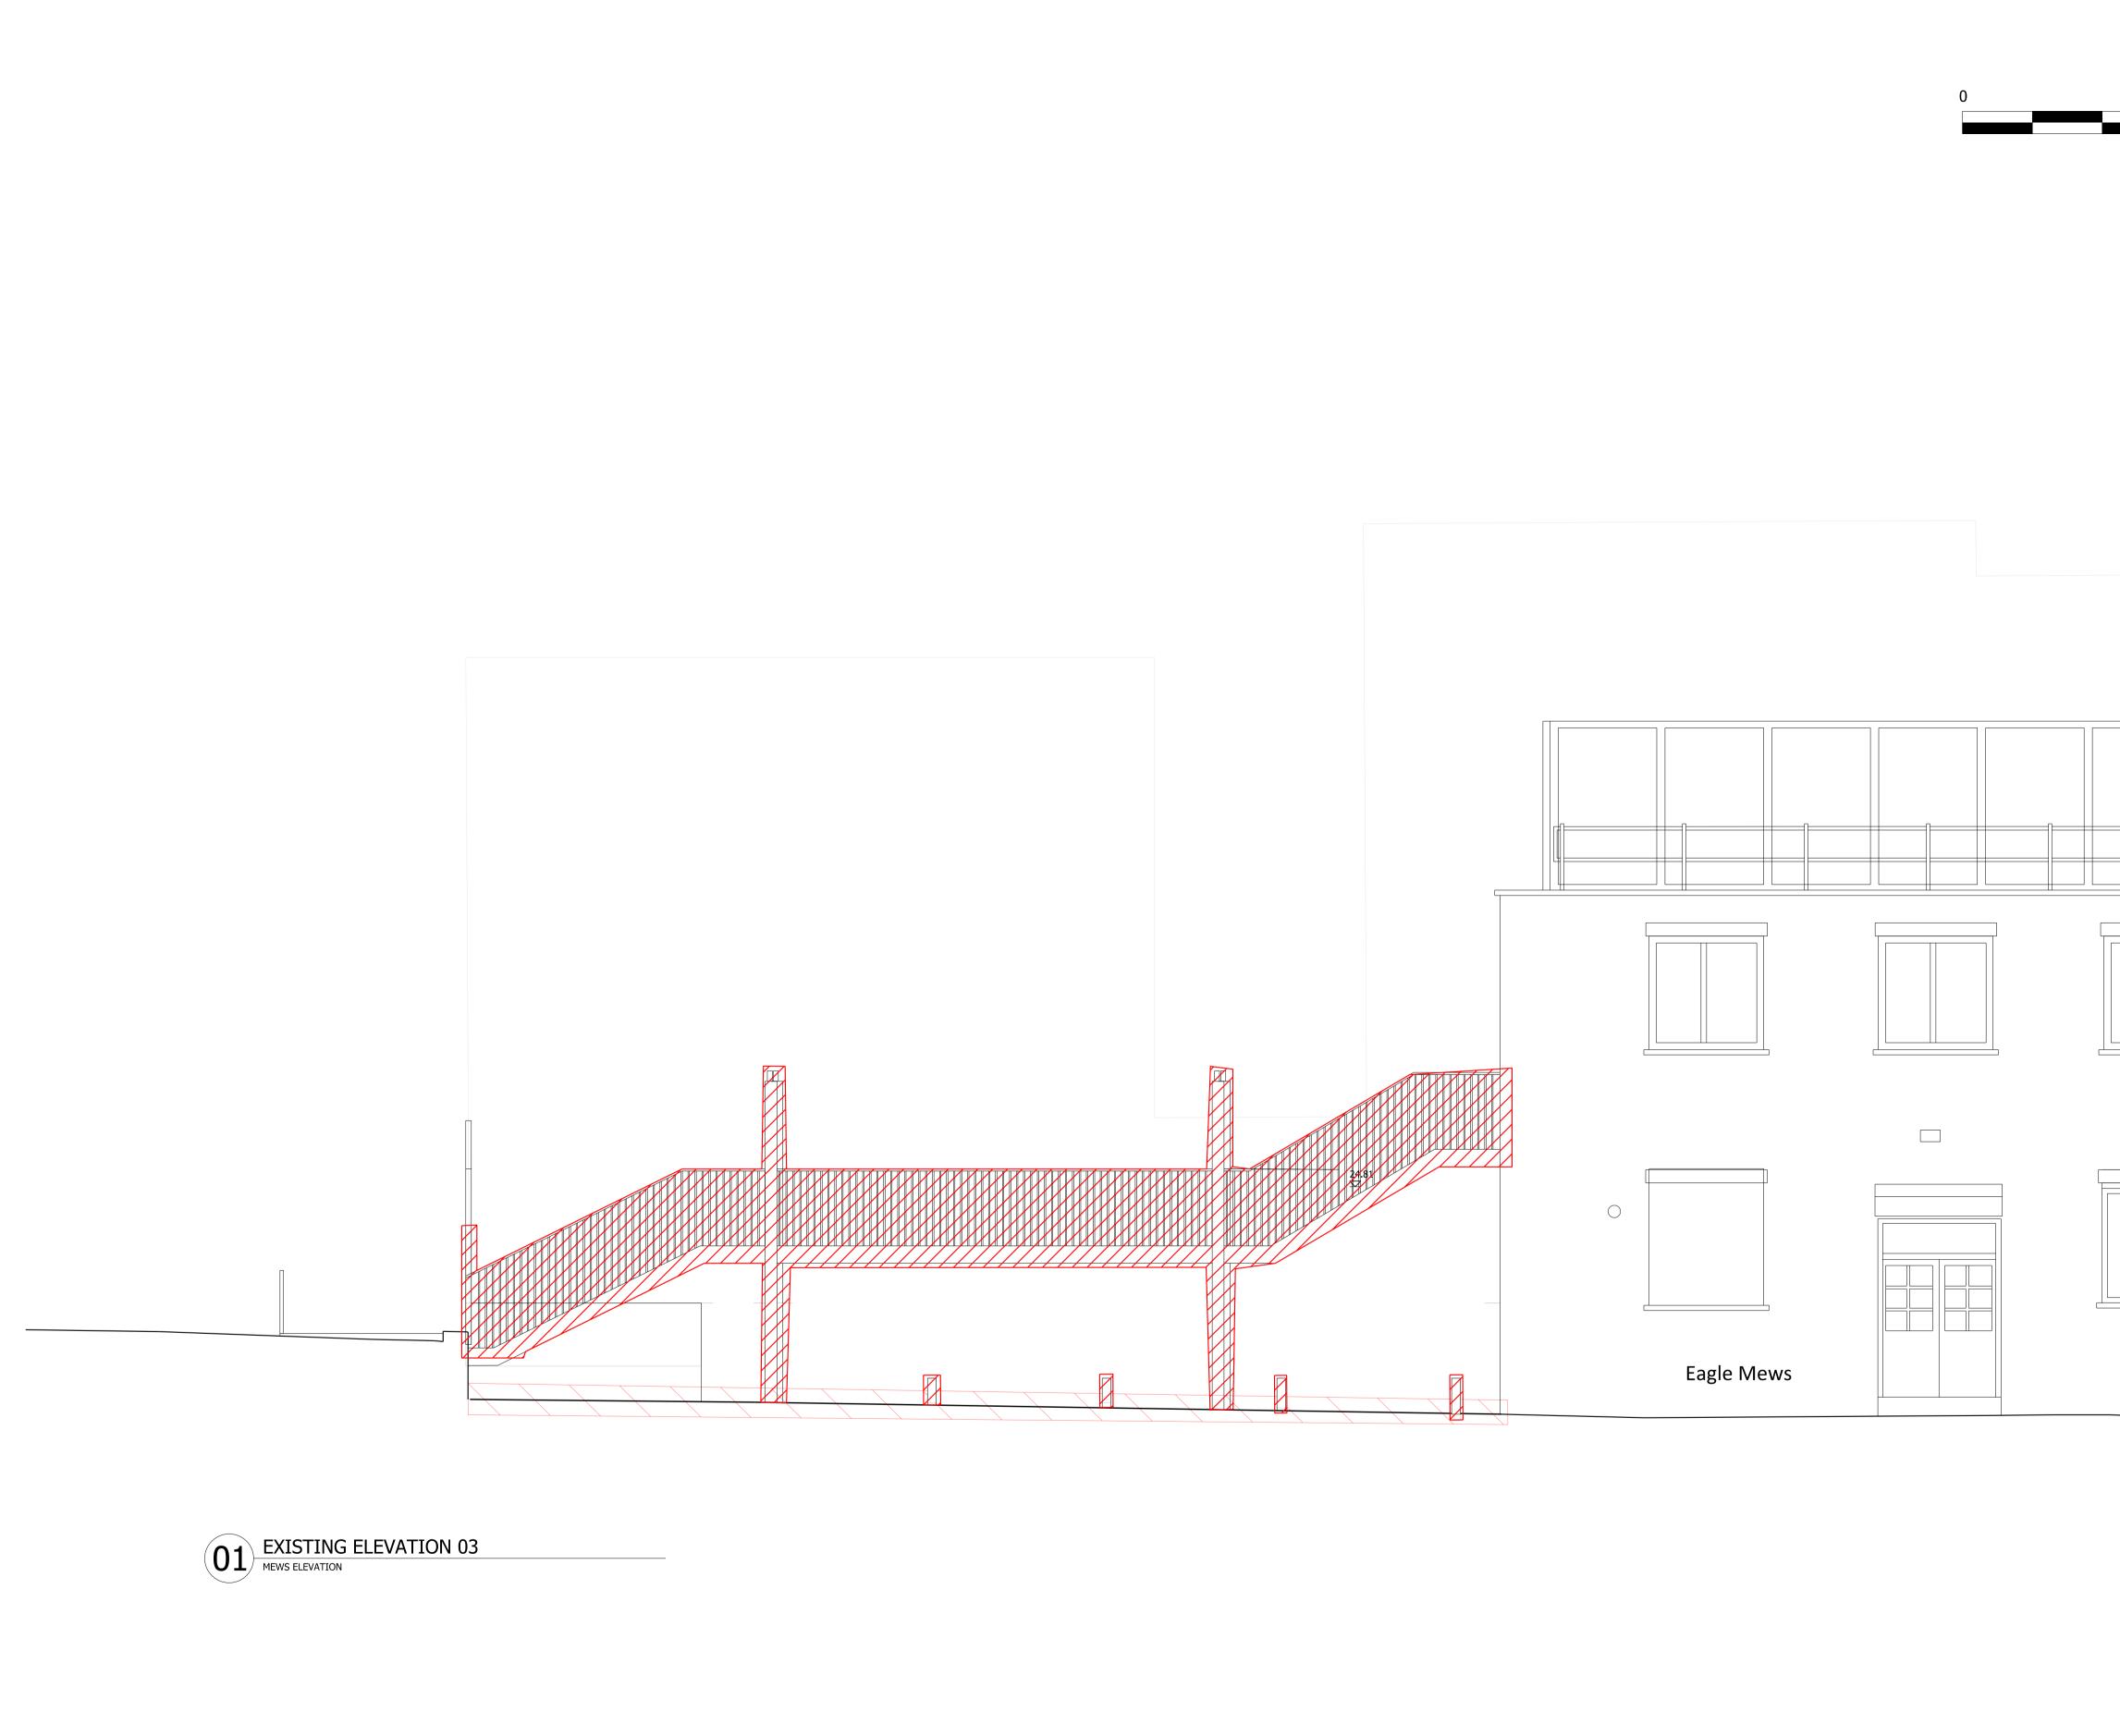


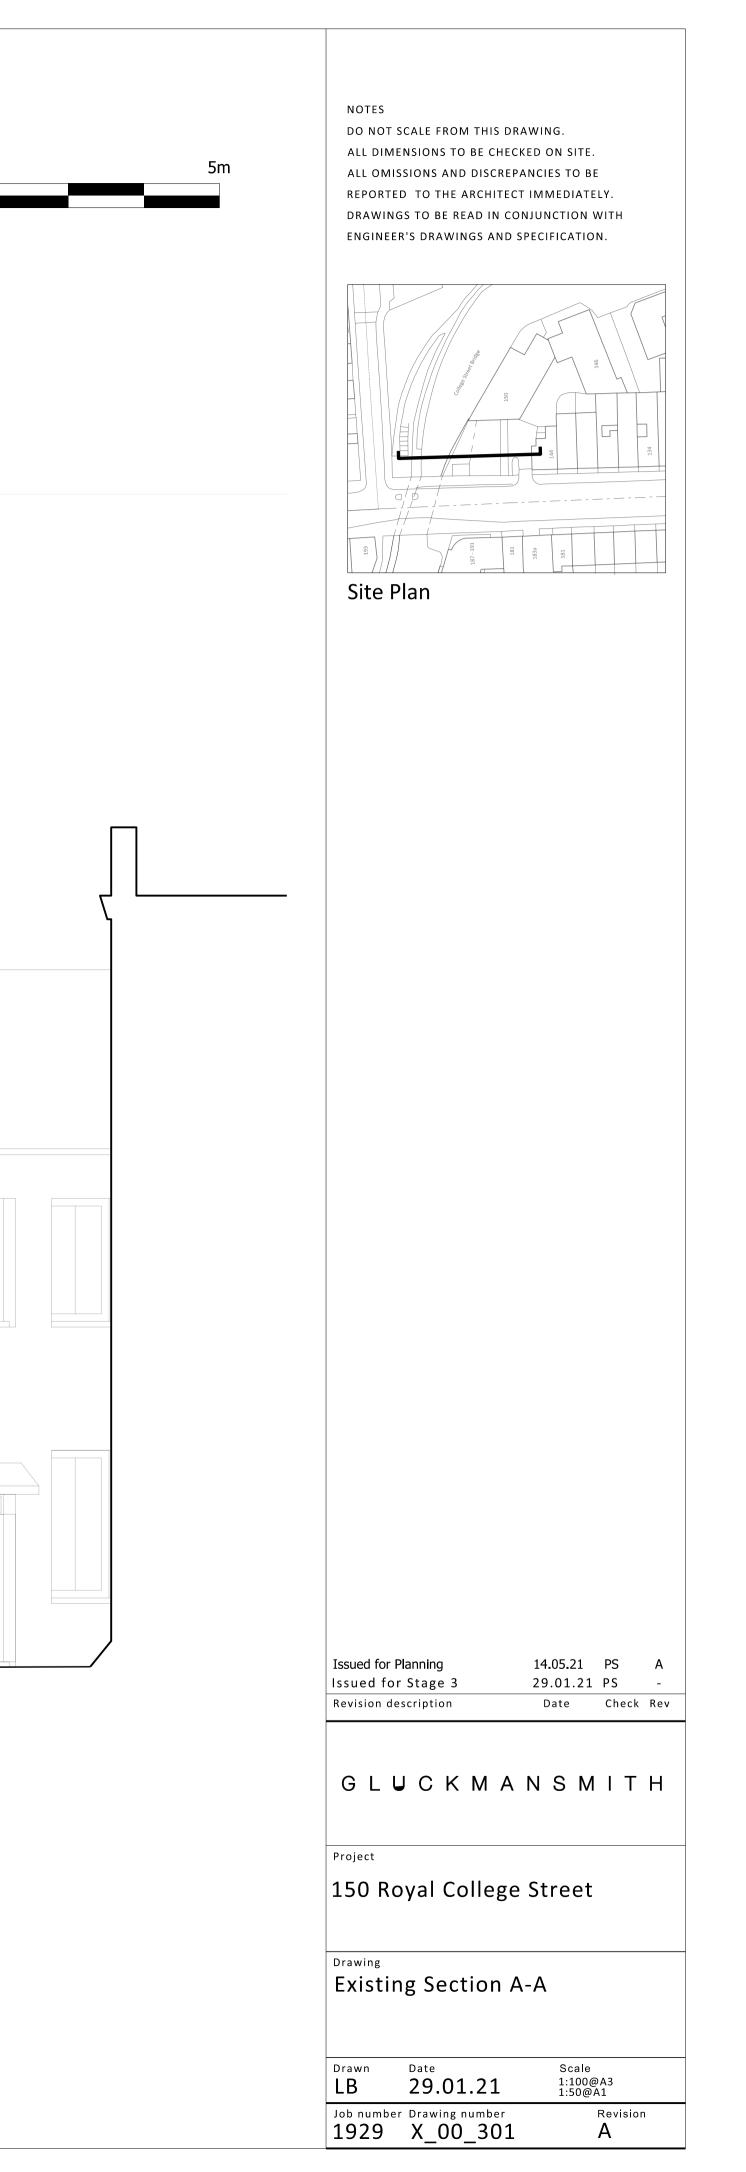

Regents Canal			
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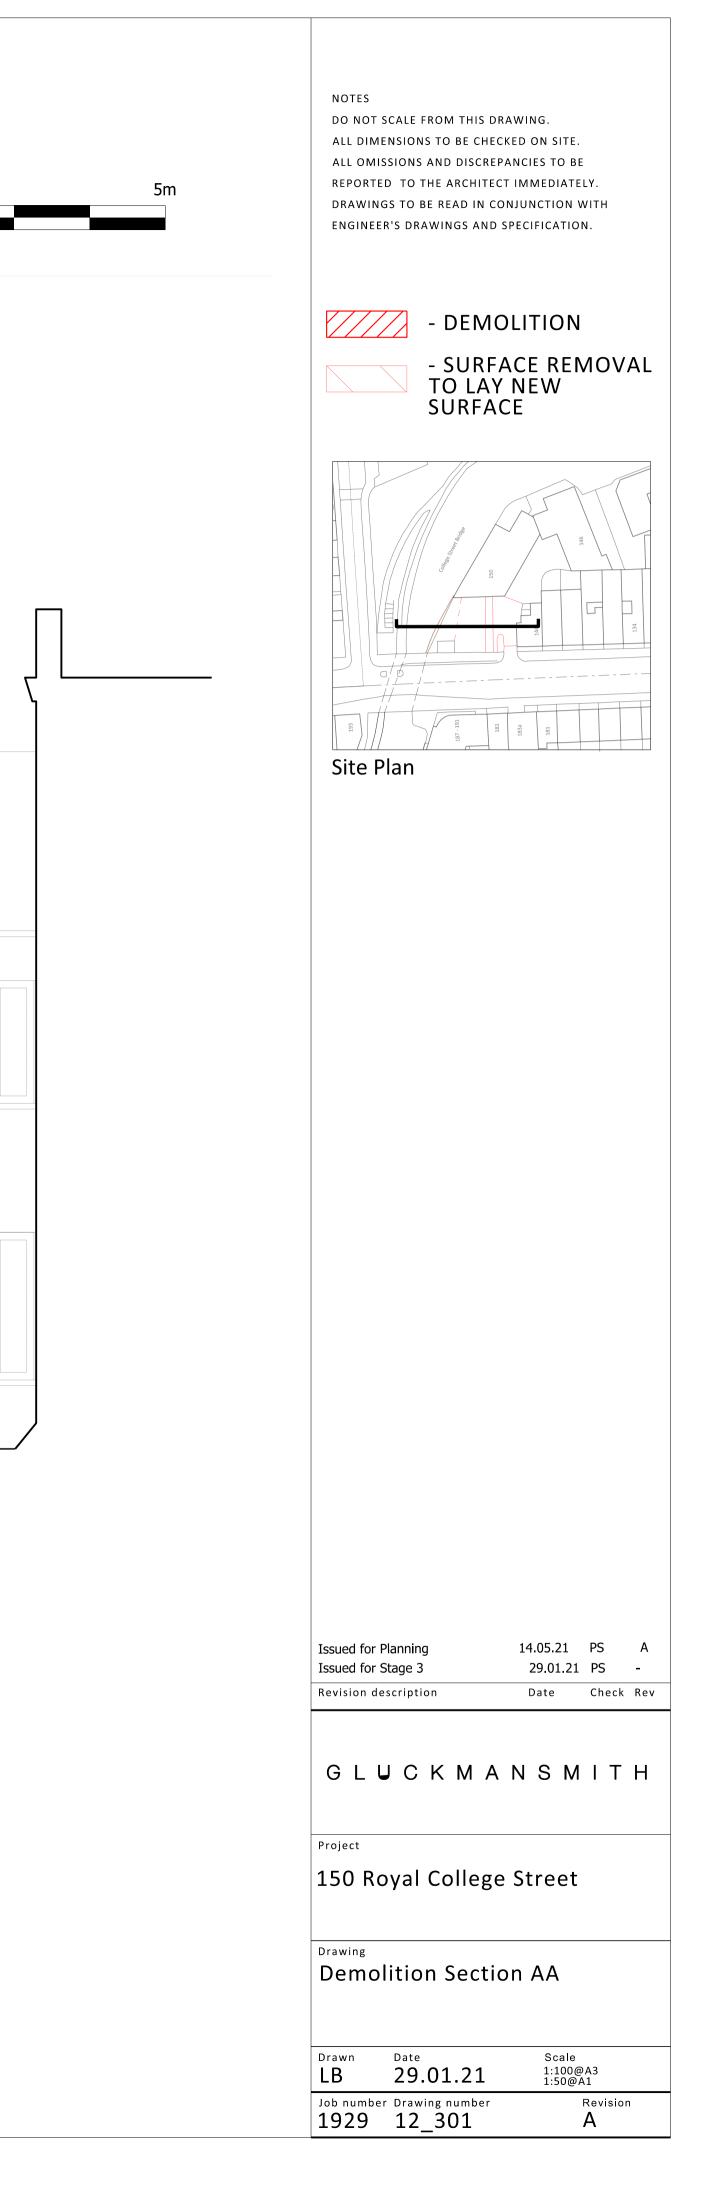
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	TO LAY NEW SURFACE
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	Revision description Date Check Rev
	GLUCKMANSMITH Project
	150 Royal College Street
	Drawing Existing Elevation 2 Canal Demolition
	Drawn Date Scale LB 29.01.21 1:100@A3 1:50@A1
	Job number Drawing number Revision 1929 12_202 A

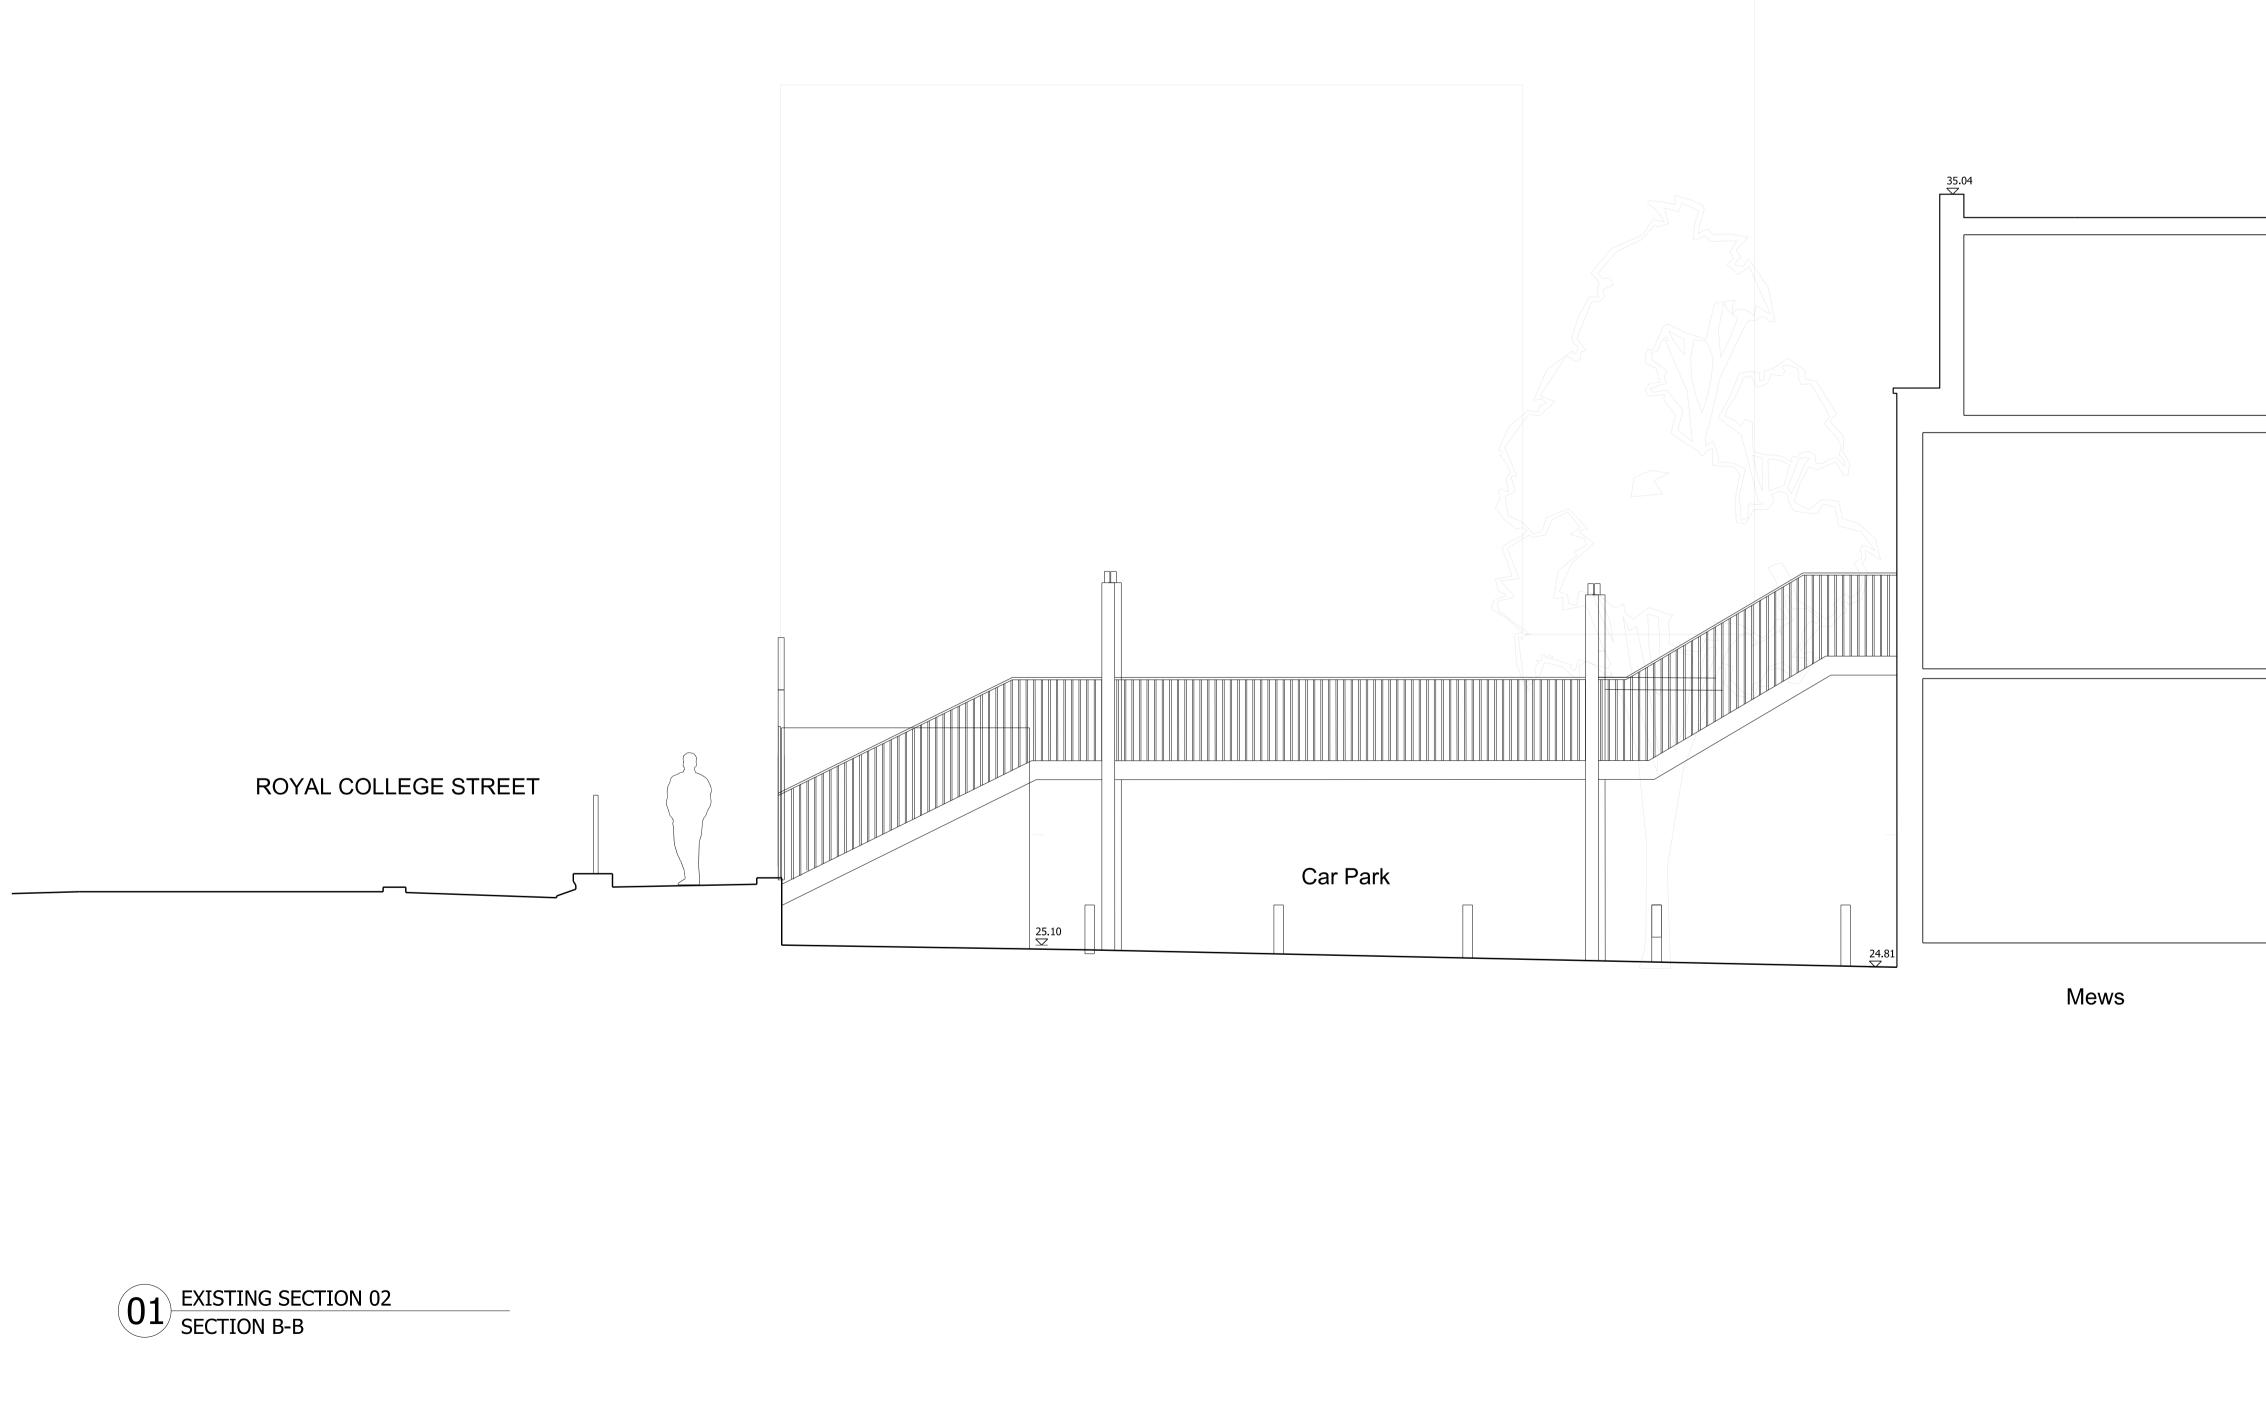

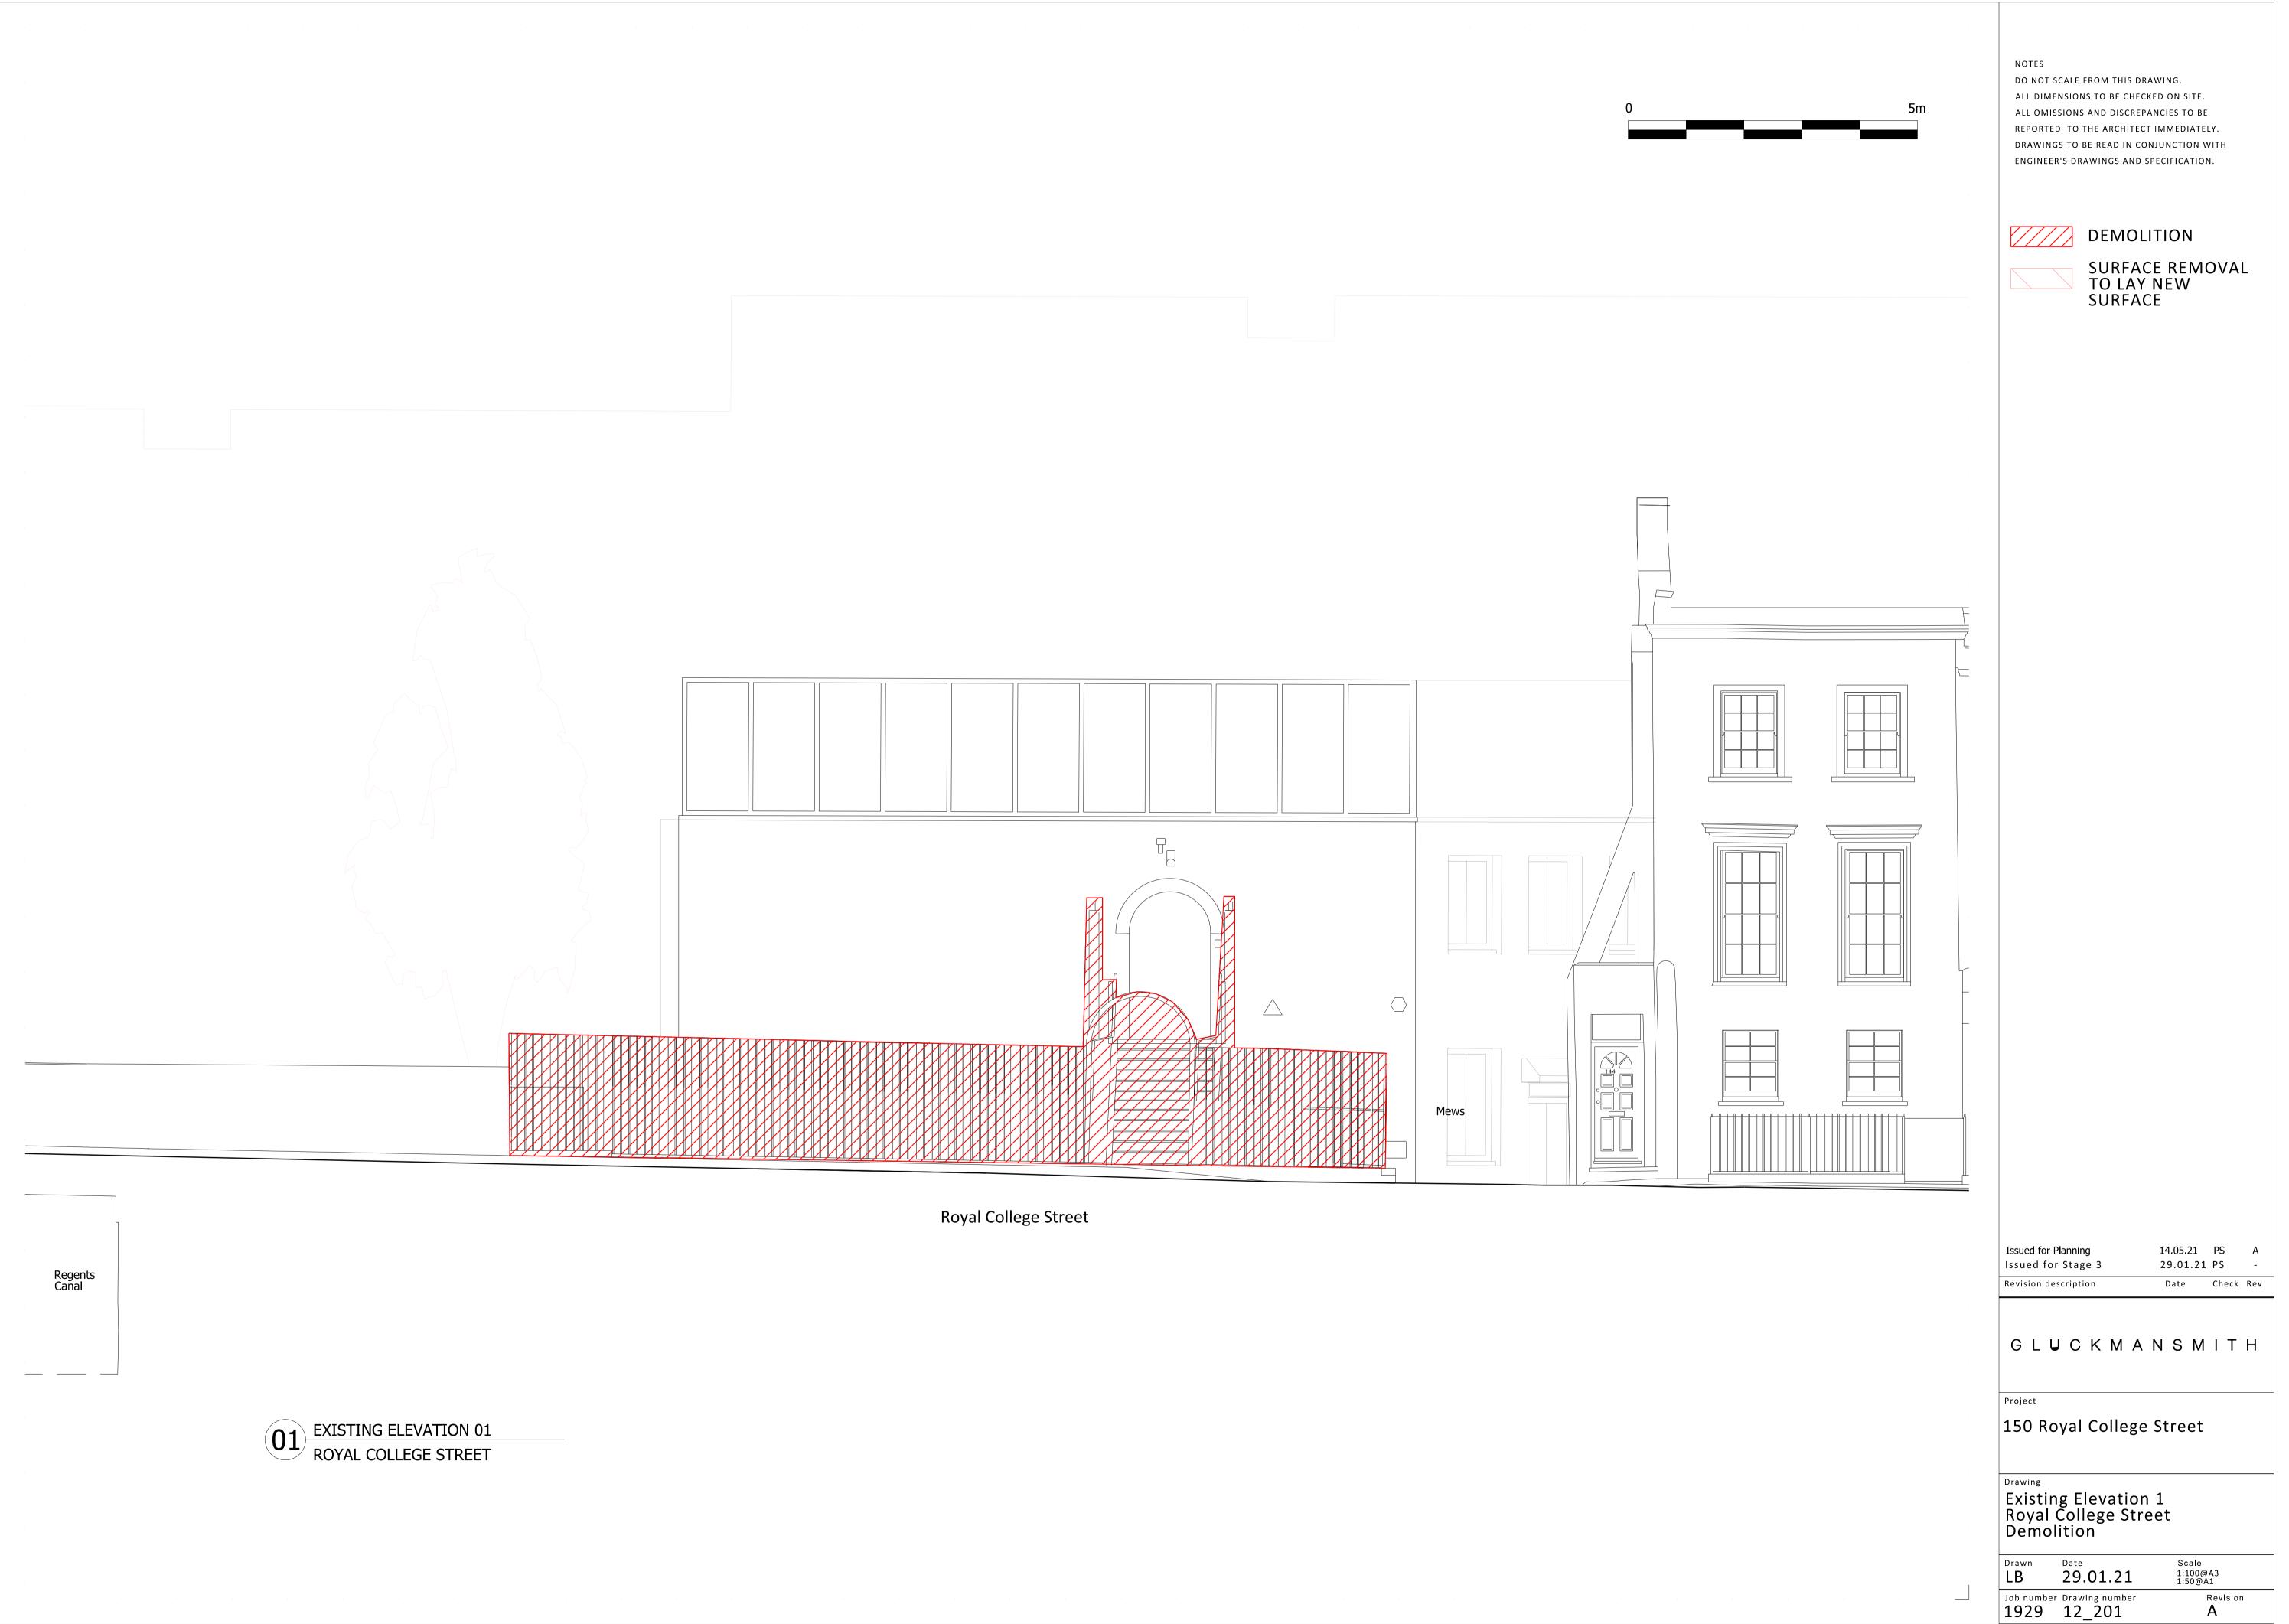
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	Project 150 Royal College Street Drawing Existing Elevation 03 Mews Demolition Drawn Date Scale LB 29.01.21 1:100@A3 1:50@A1 Job number Drawing number Revision 1929 12_203 A
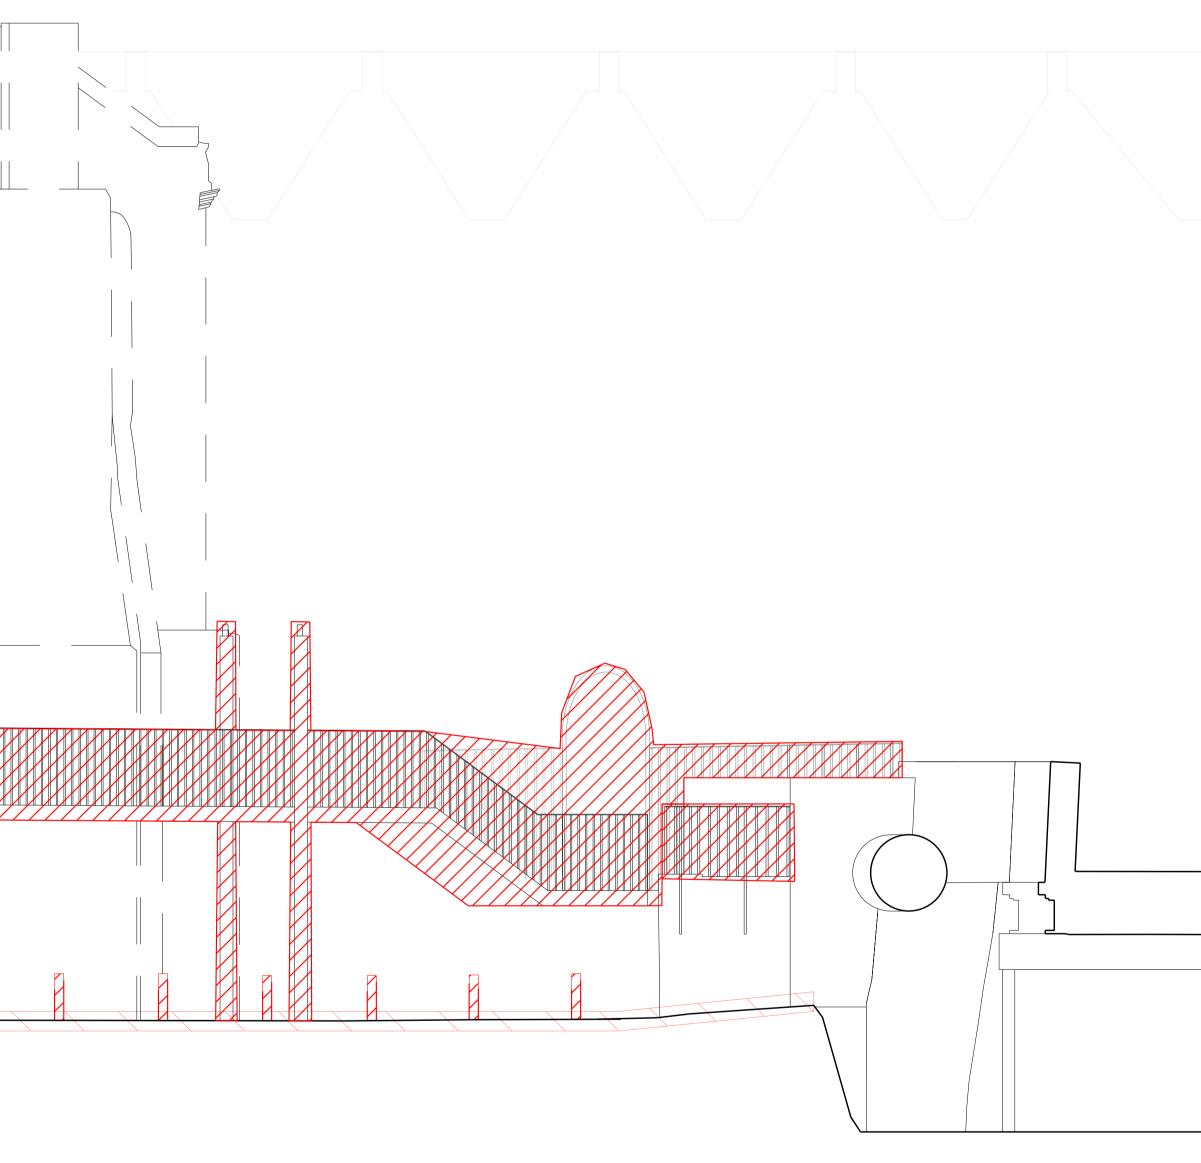
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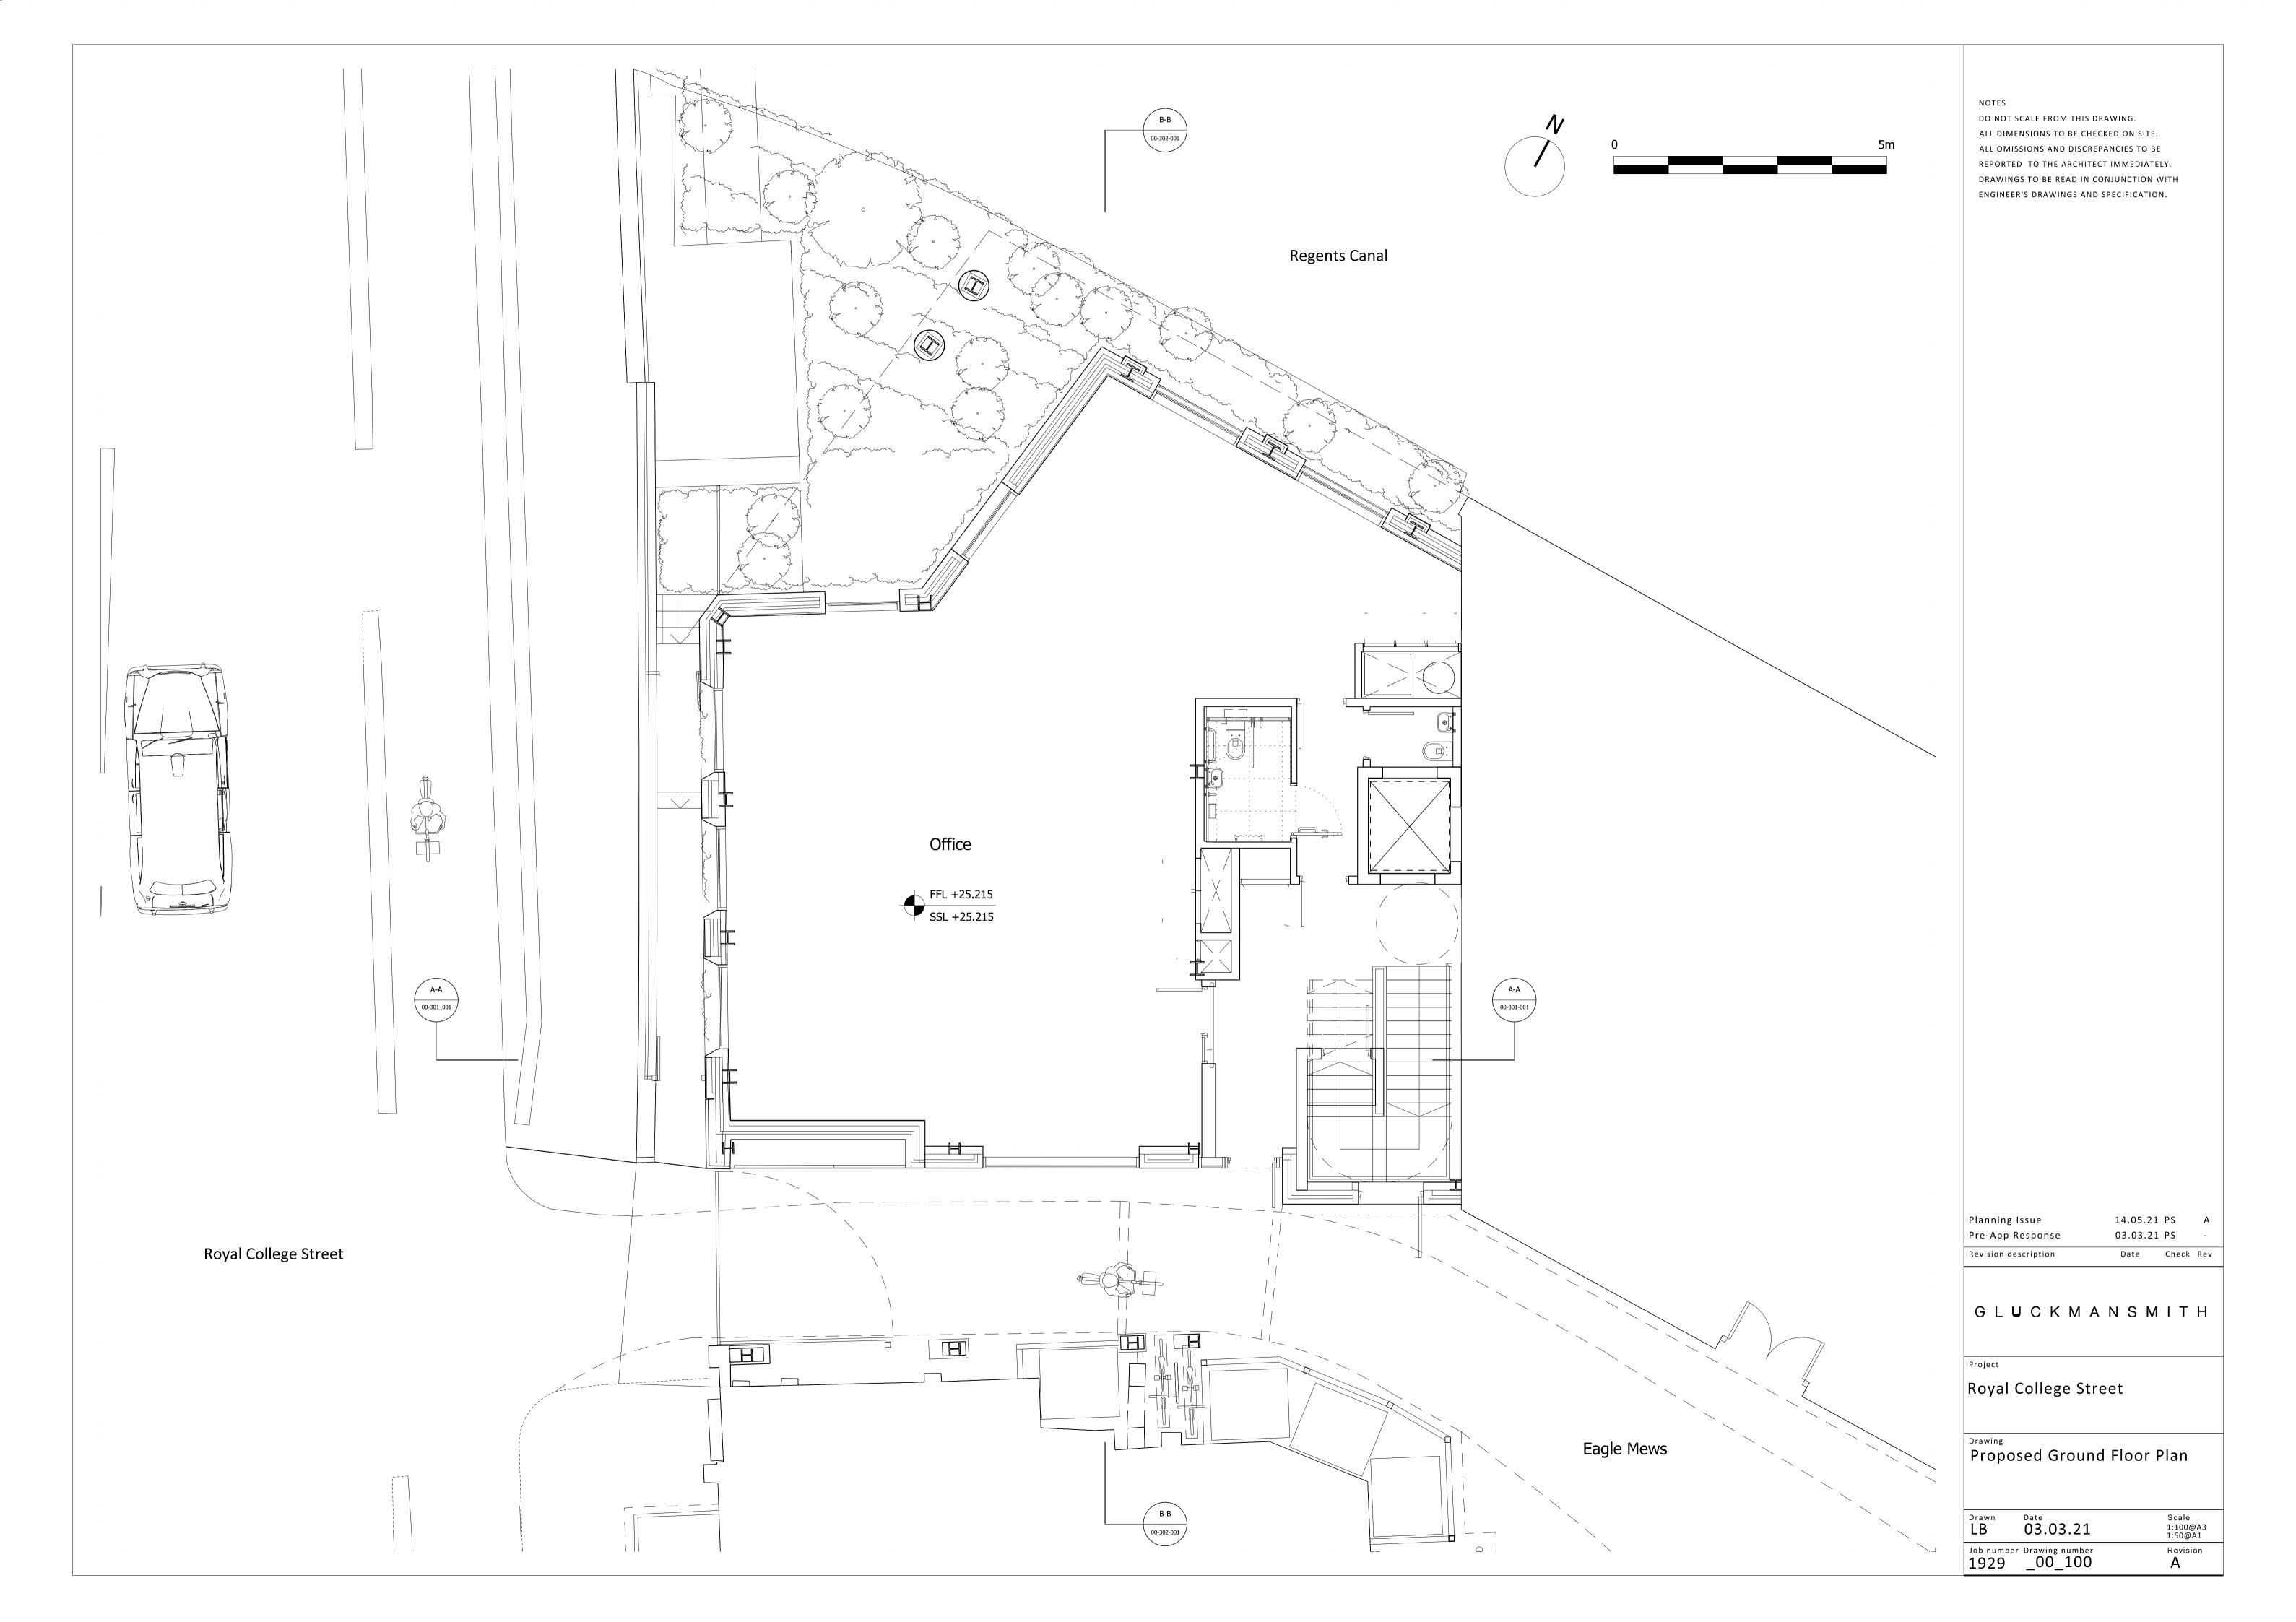






10.4 Proposed Drawings, Plans and Elevations

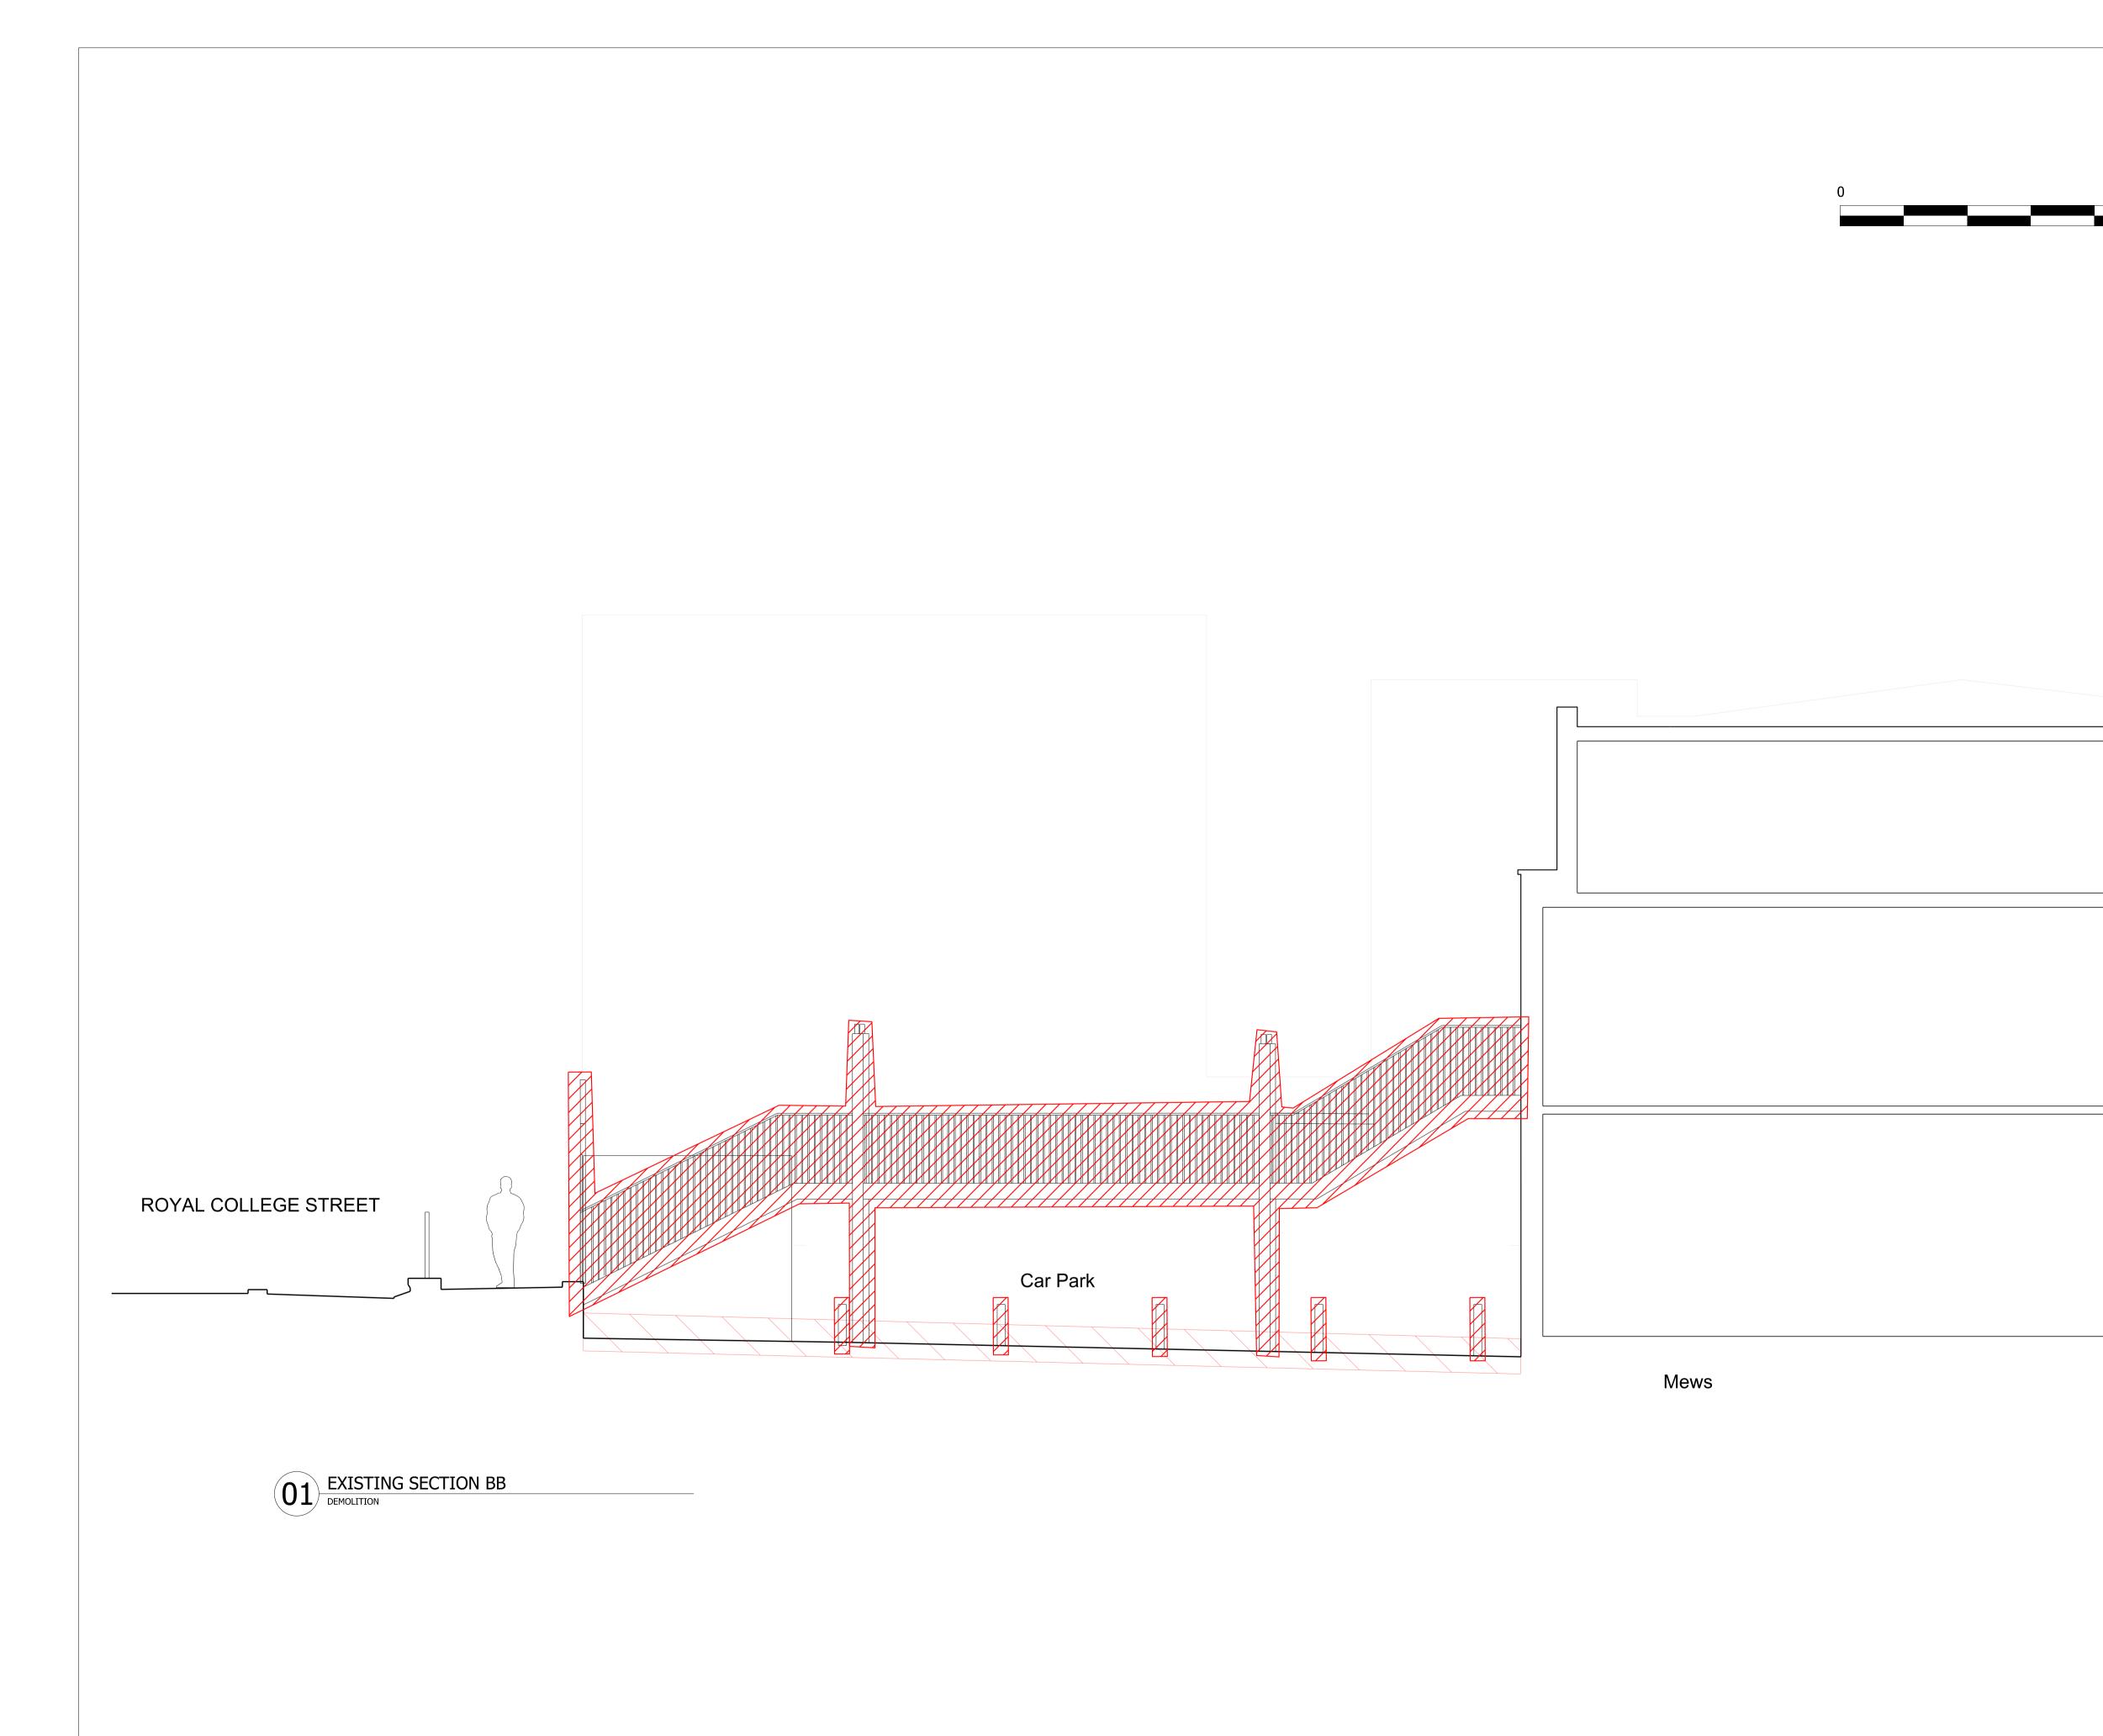
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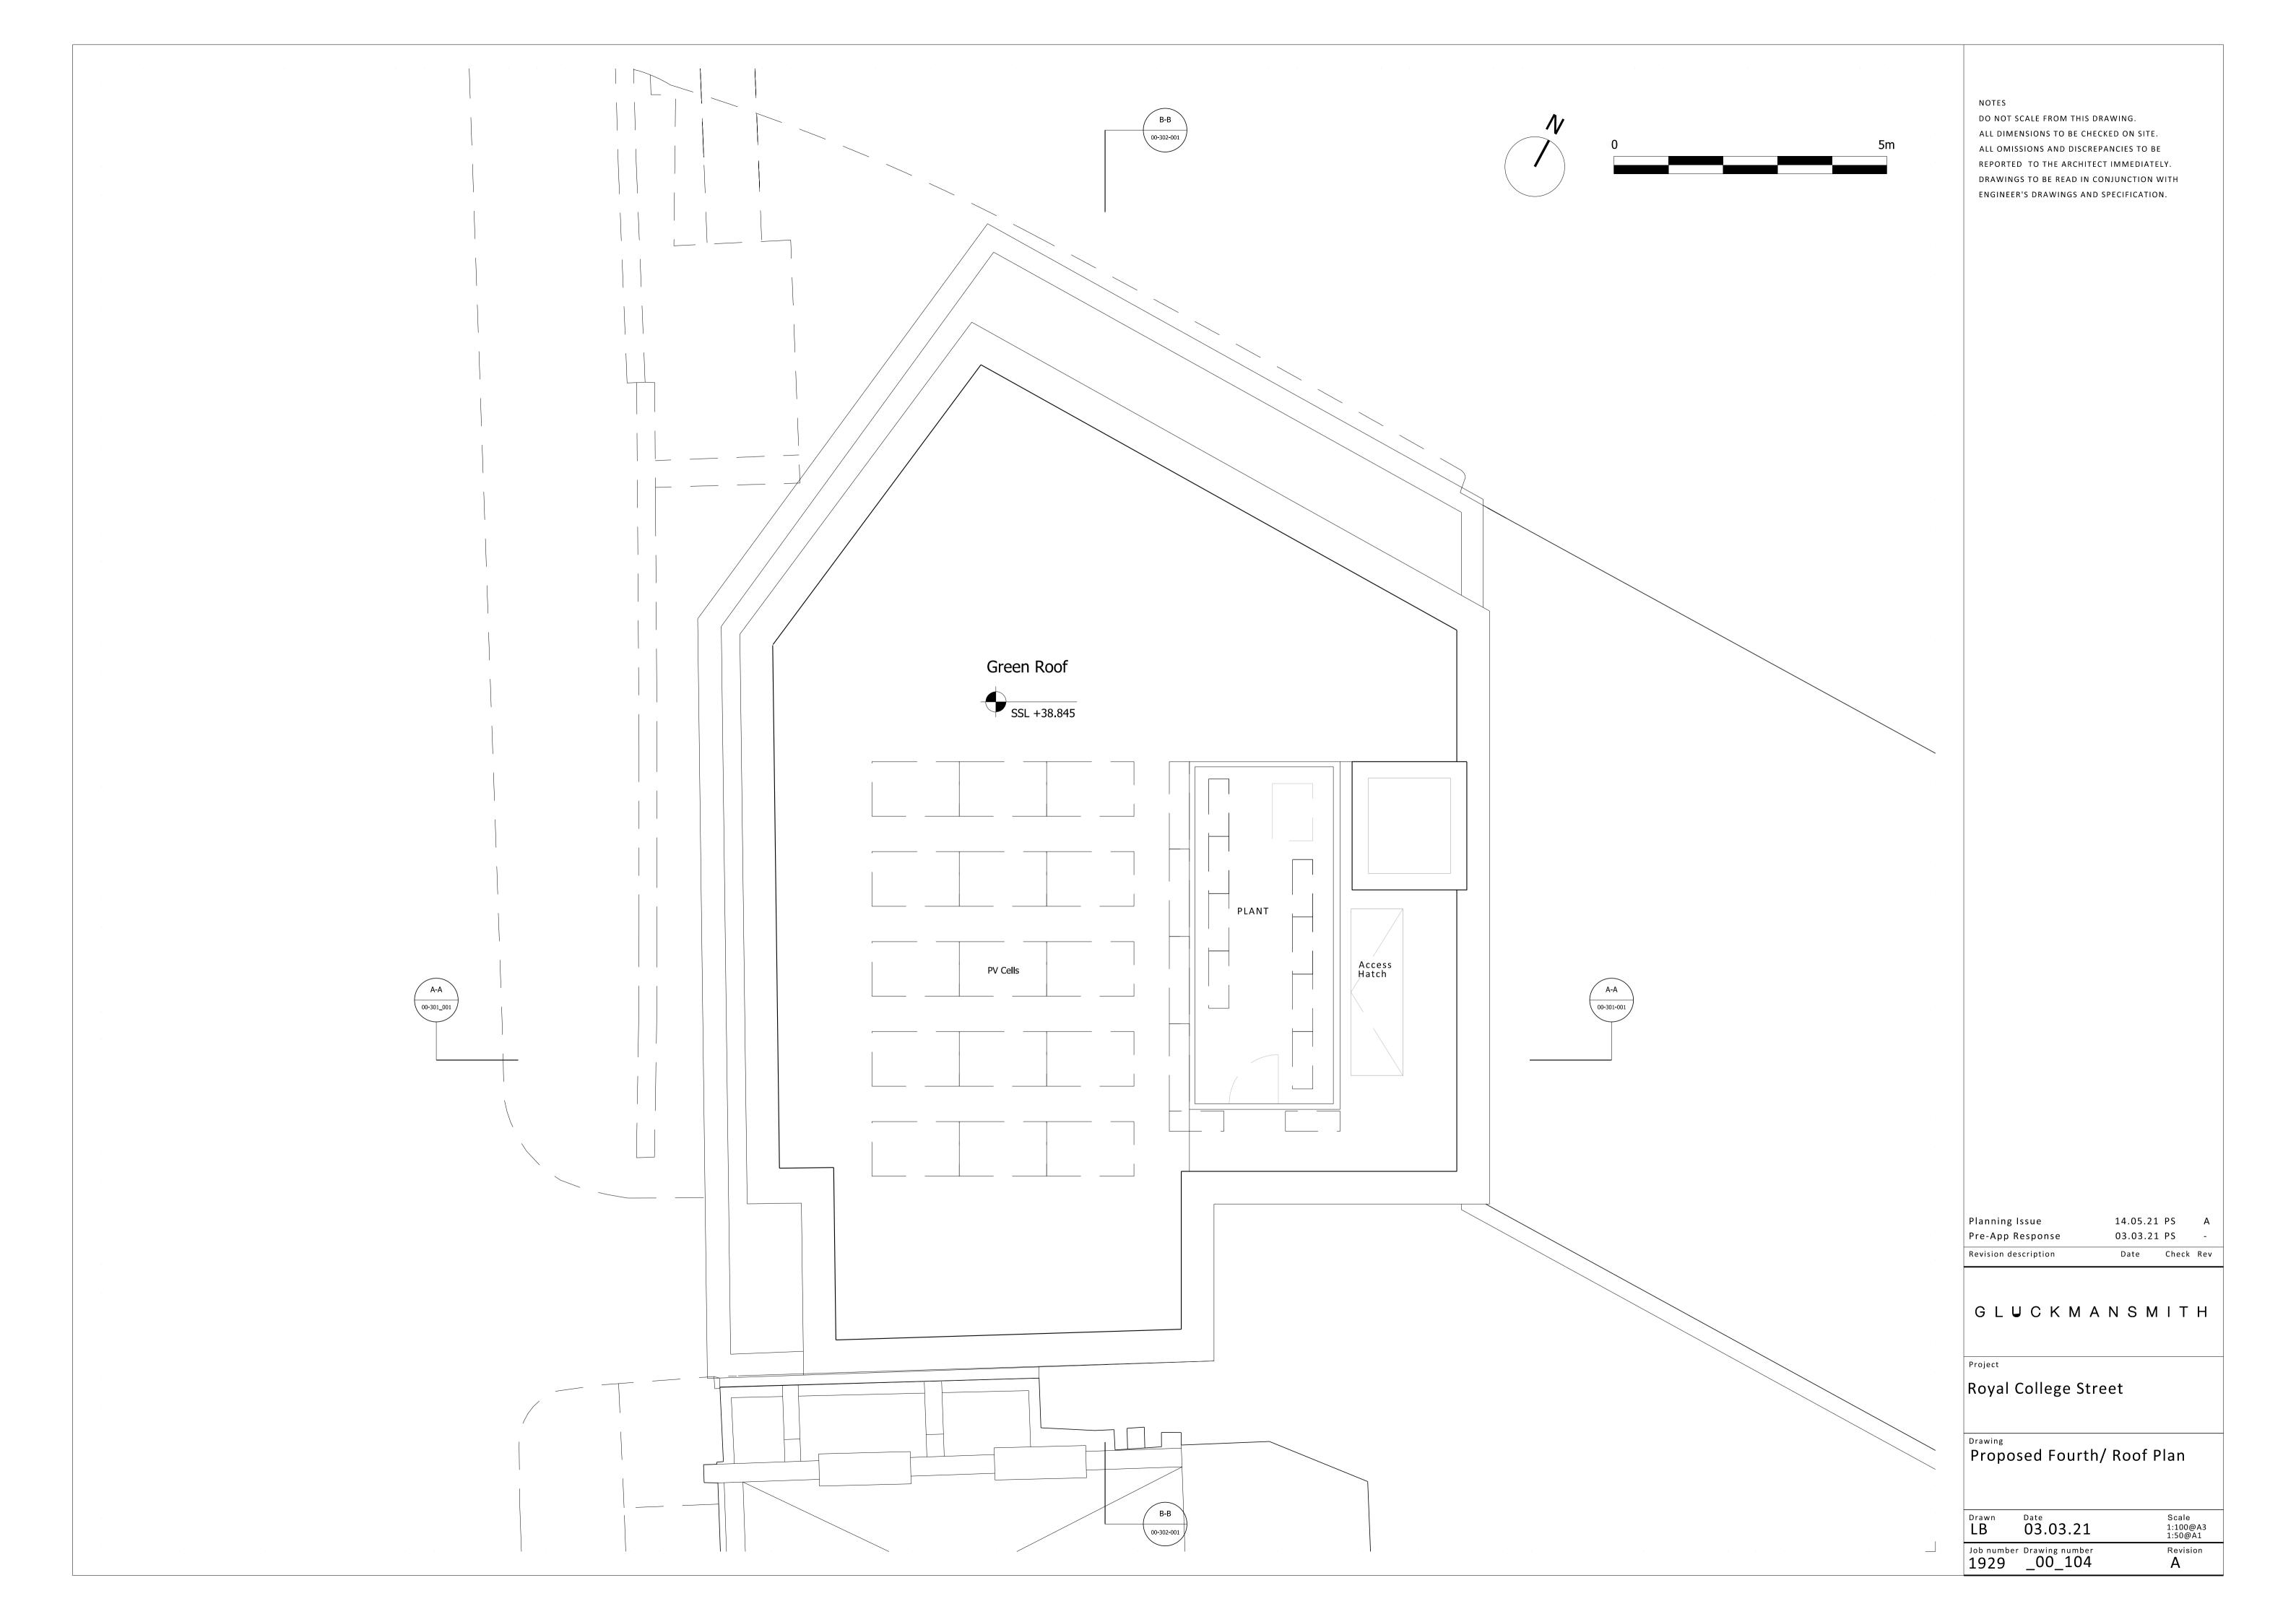






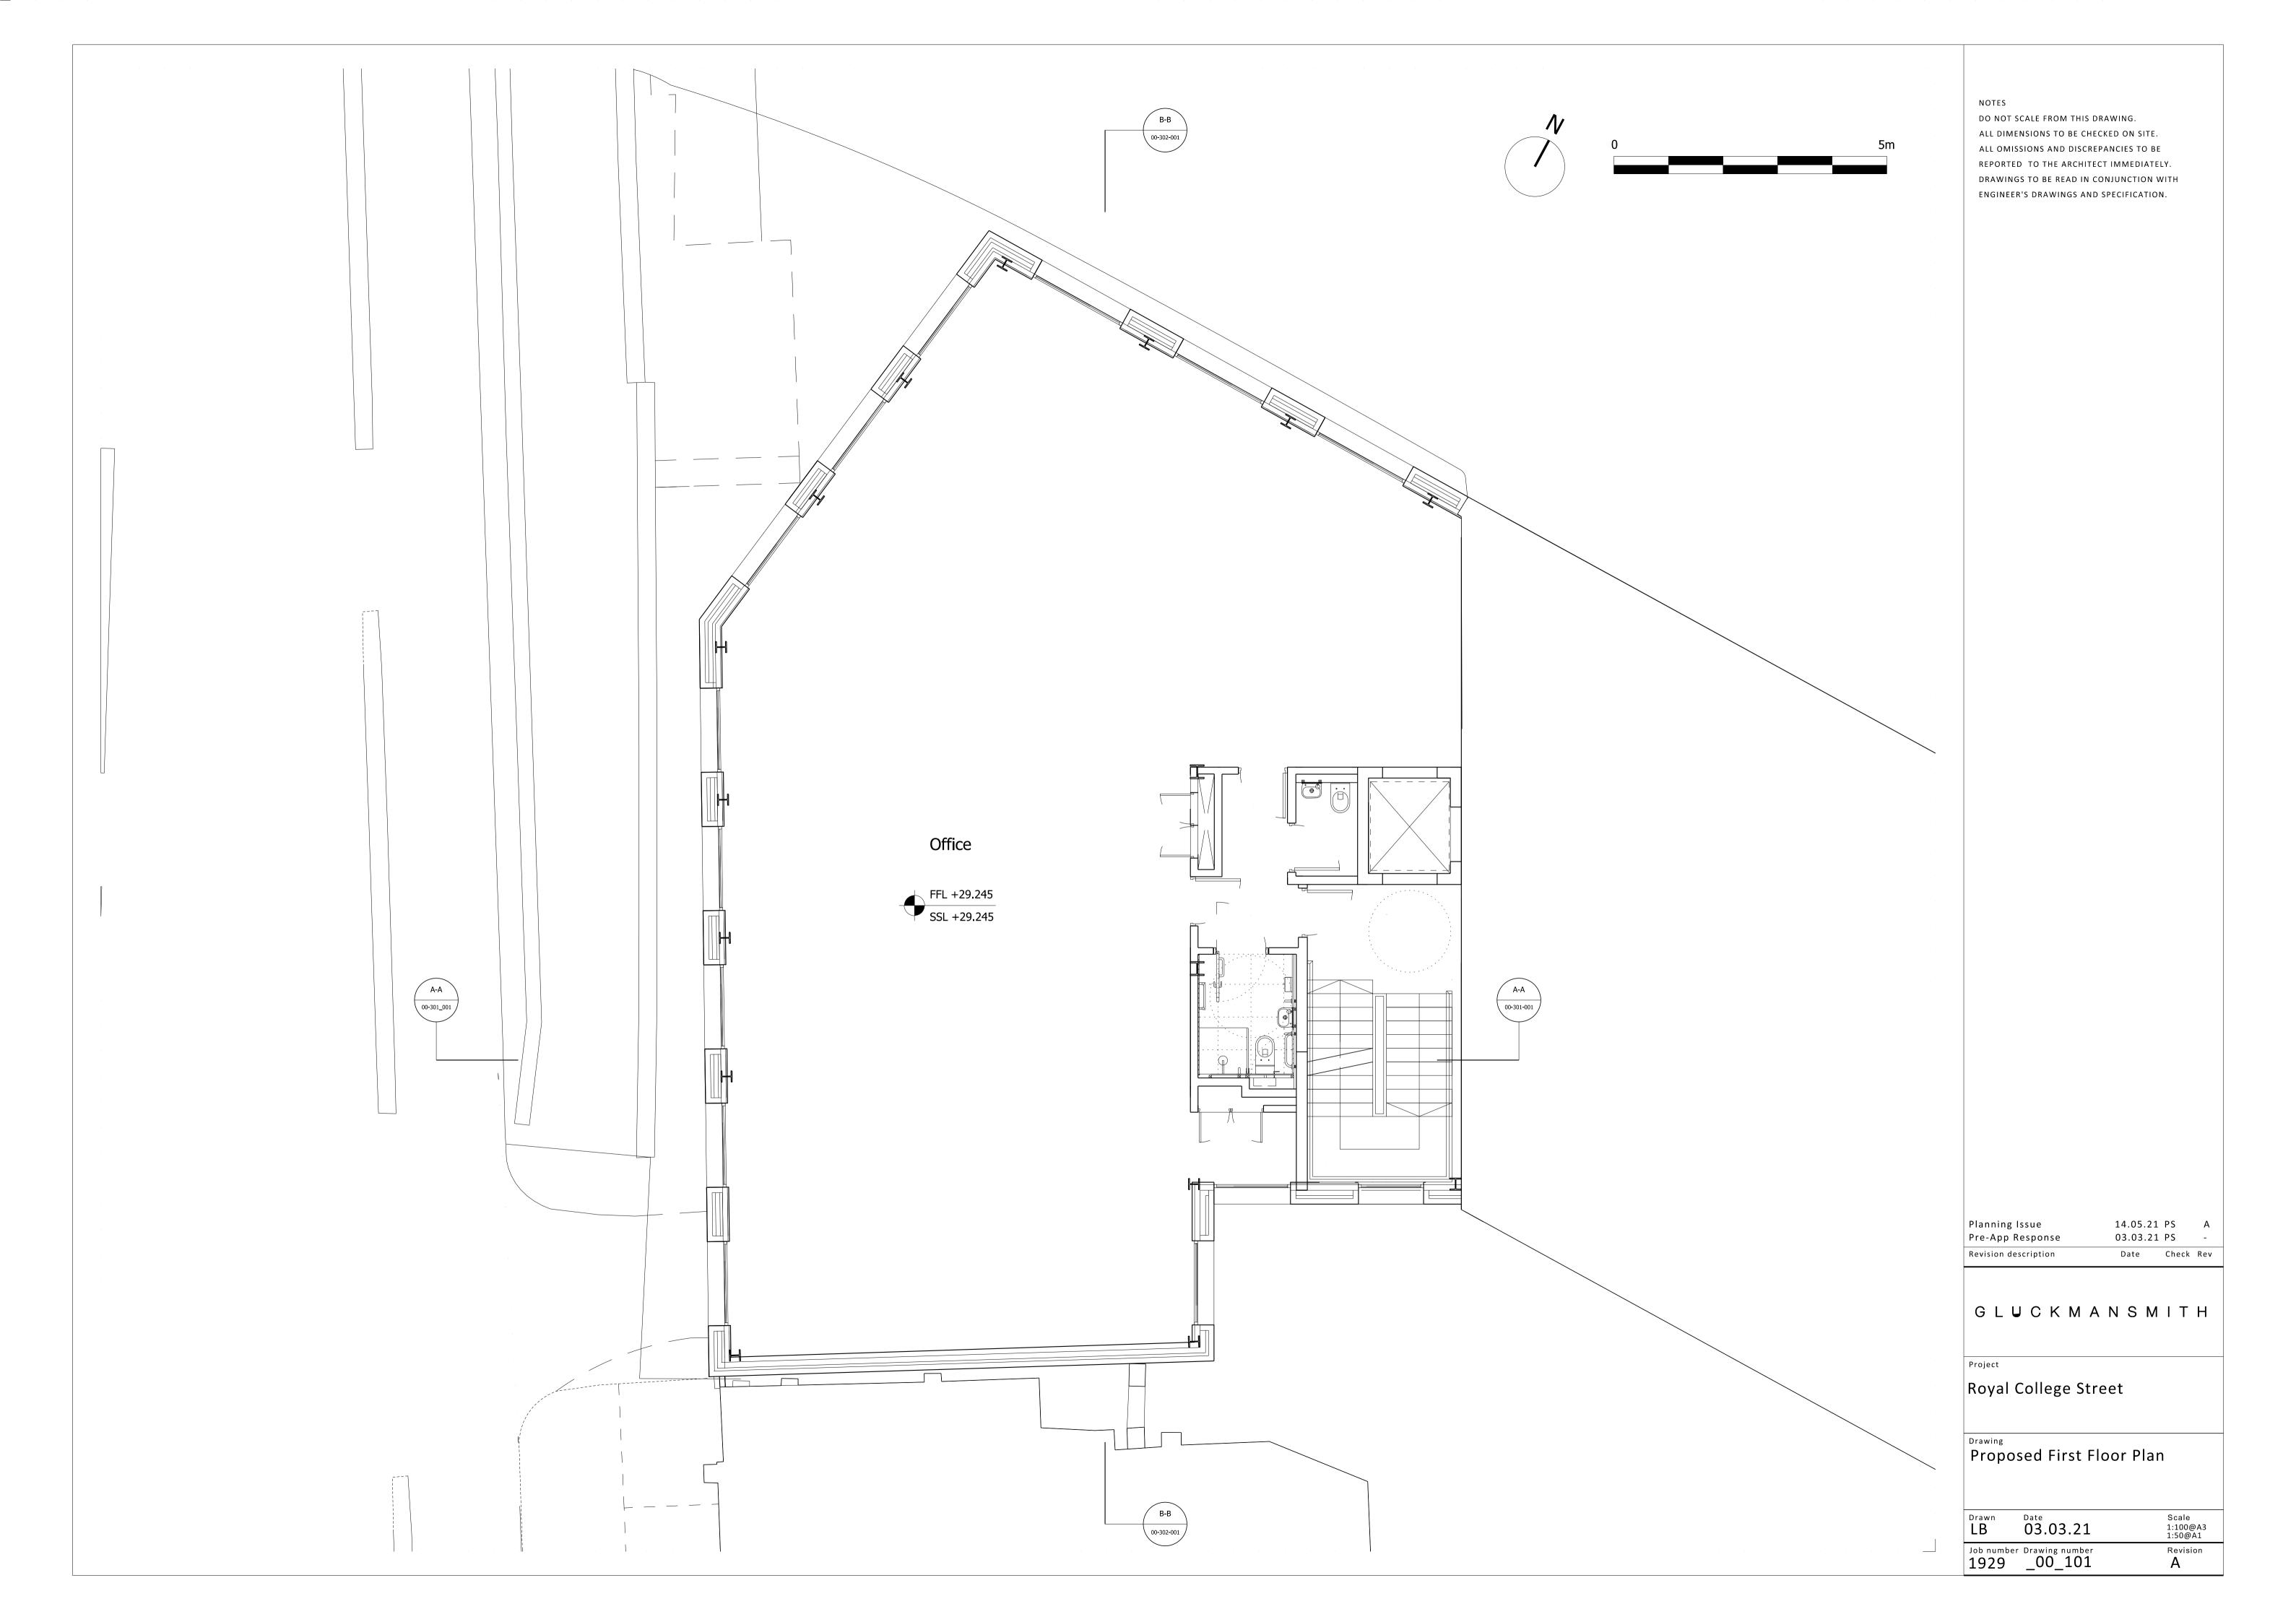

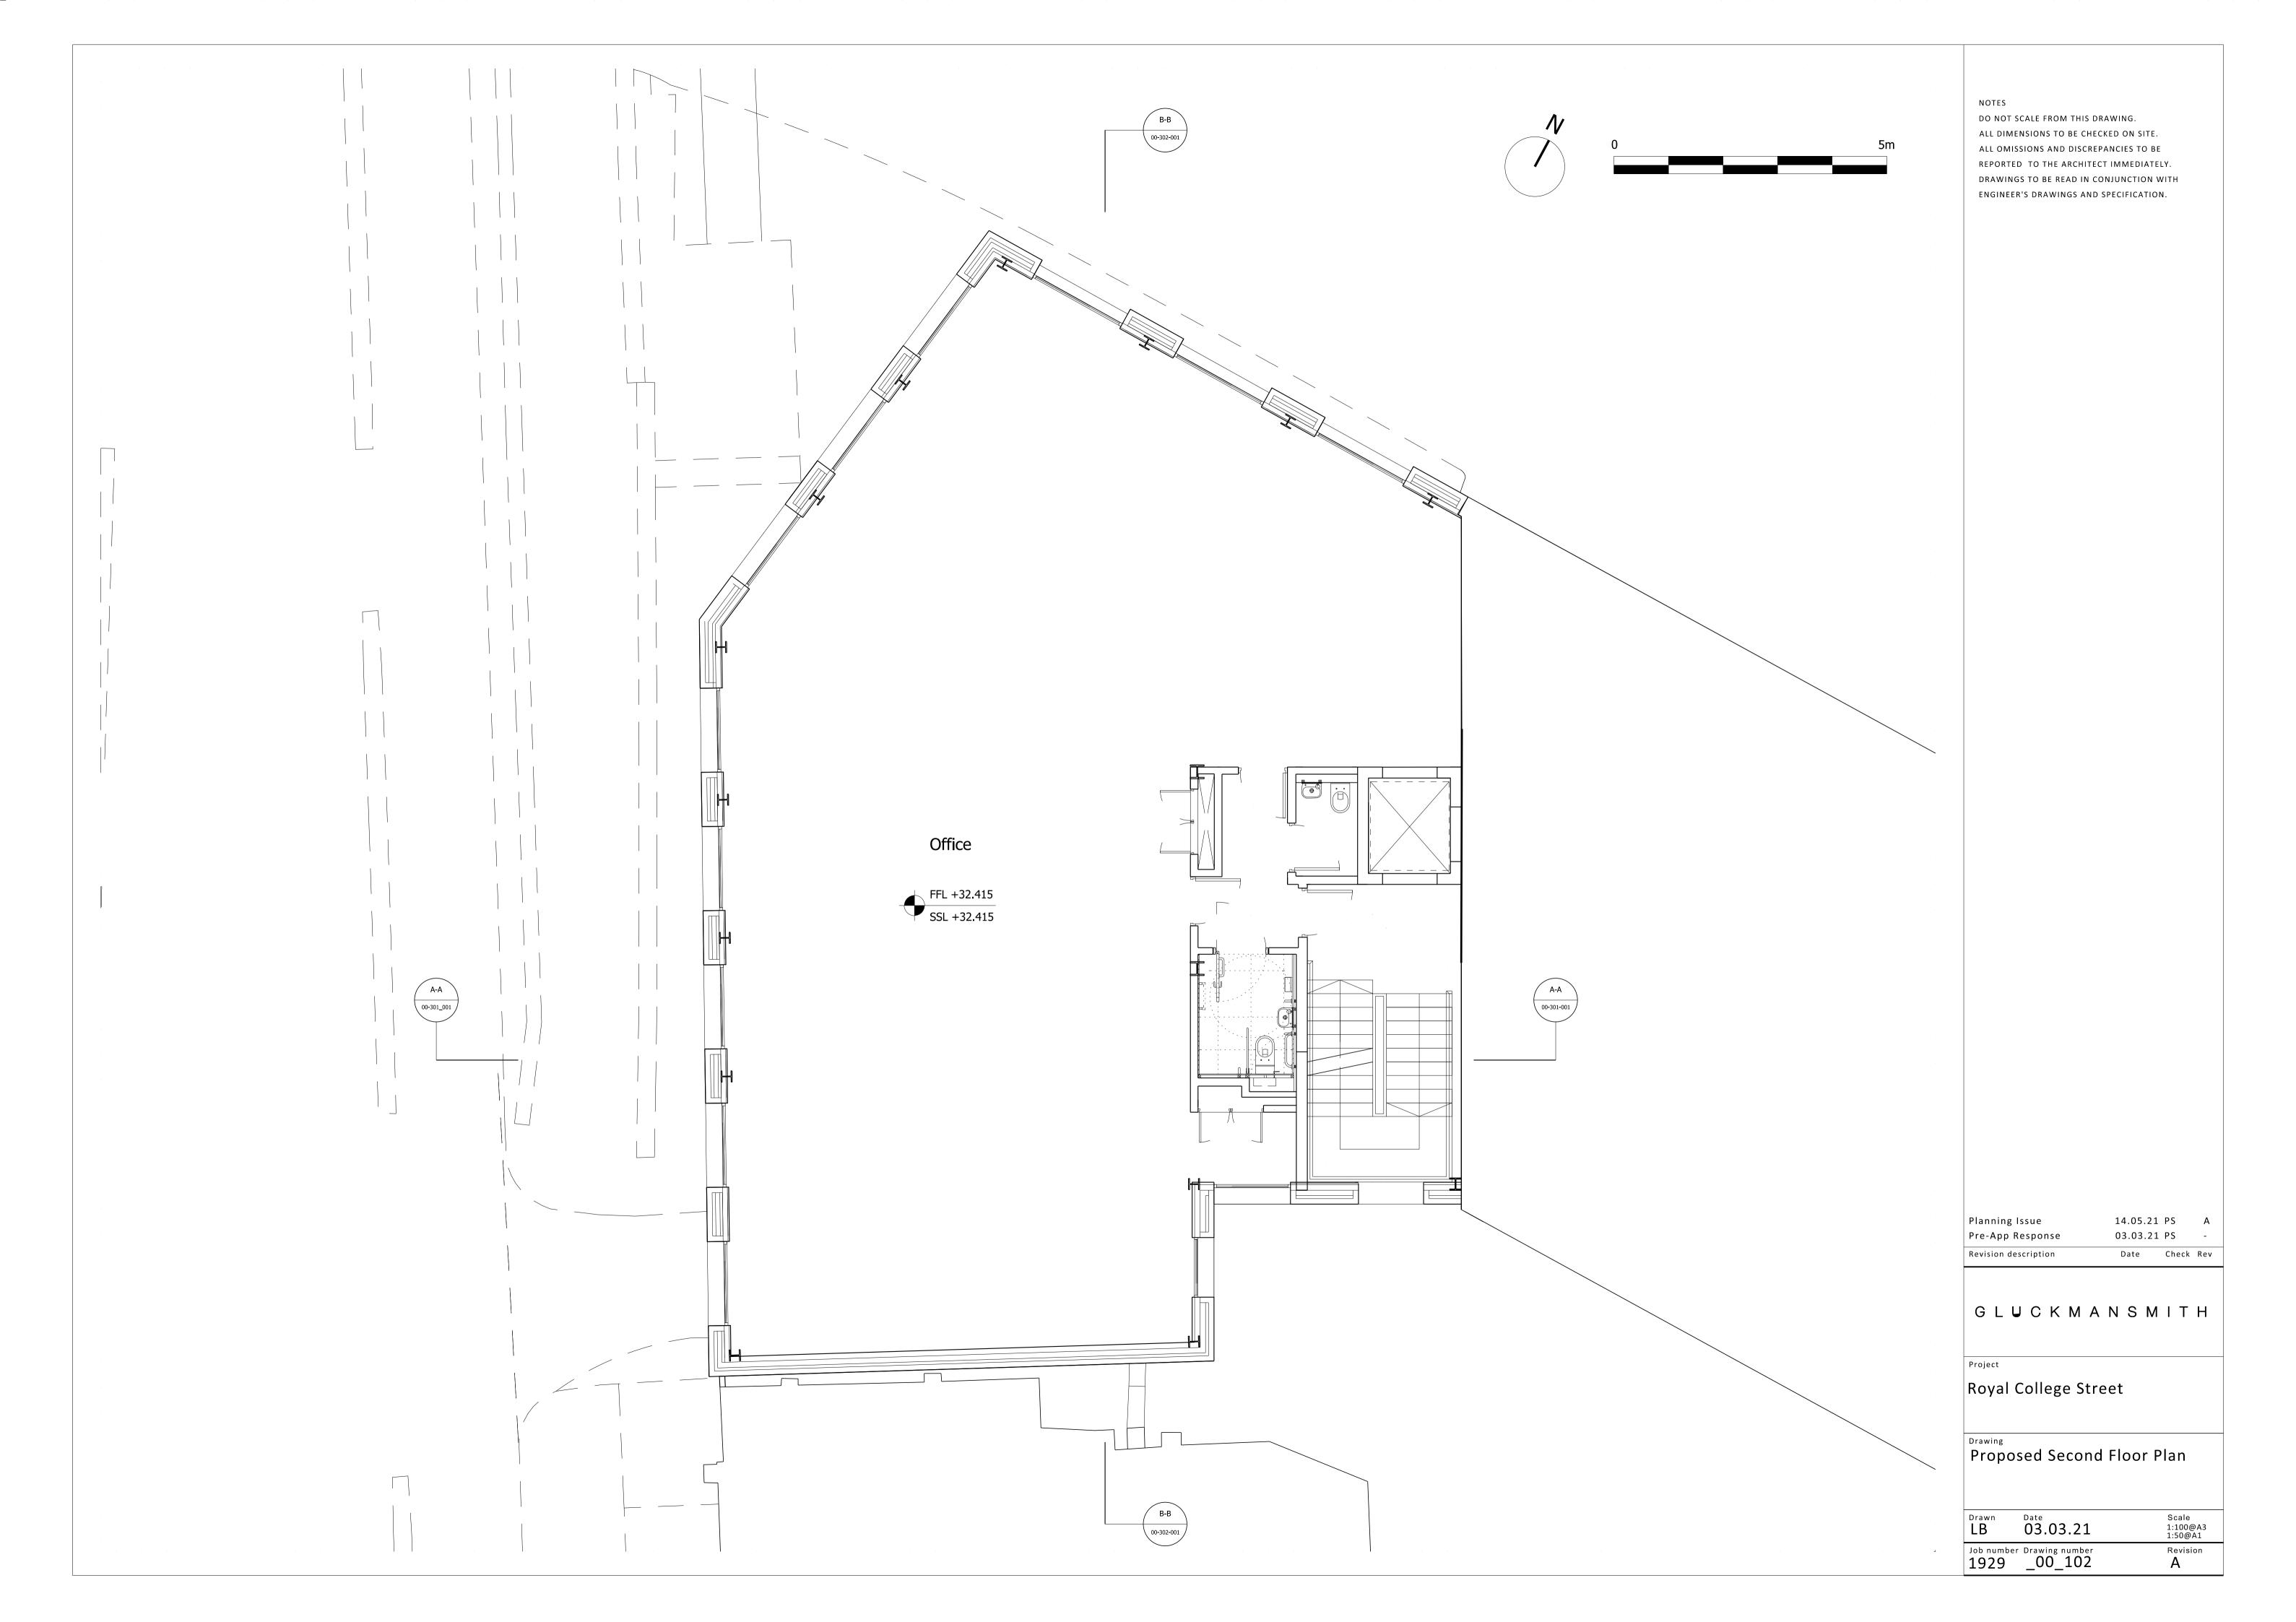


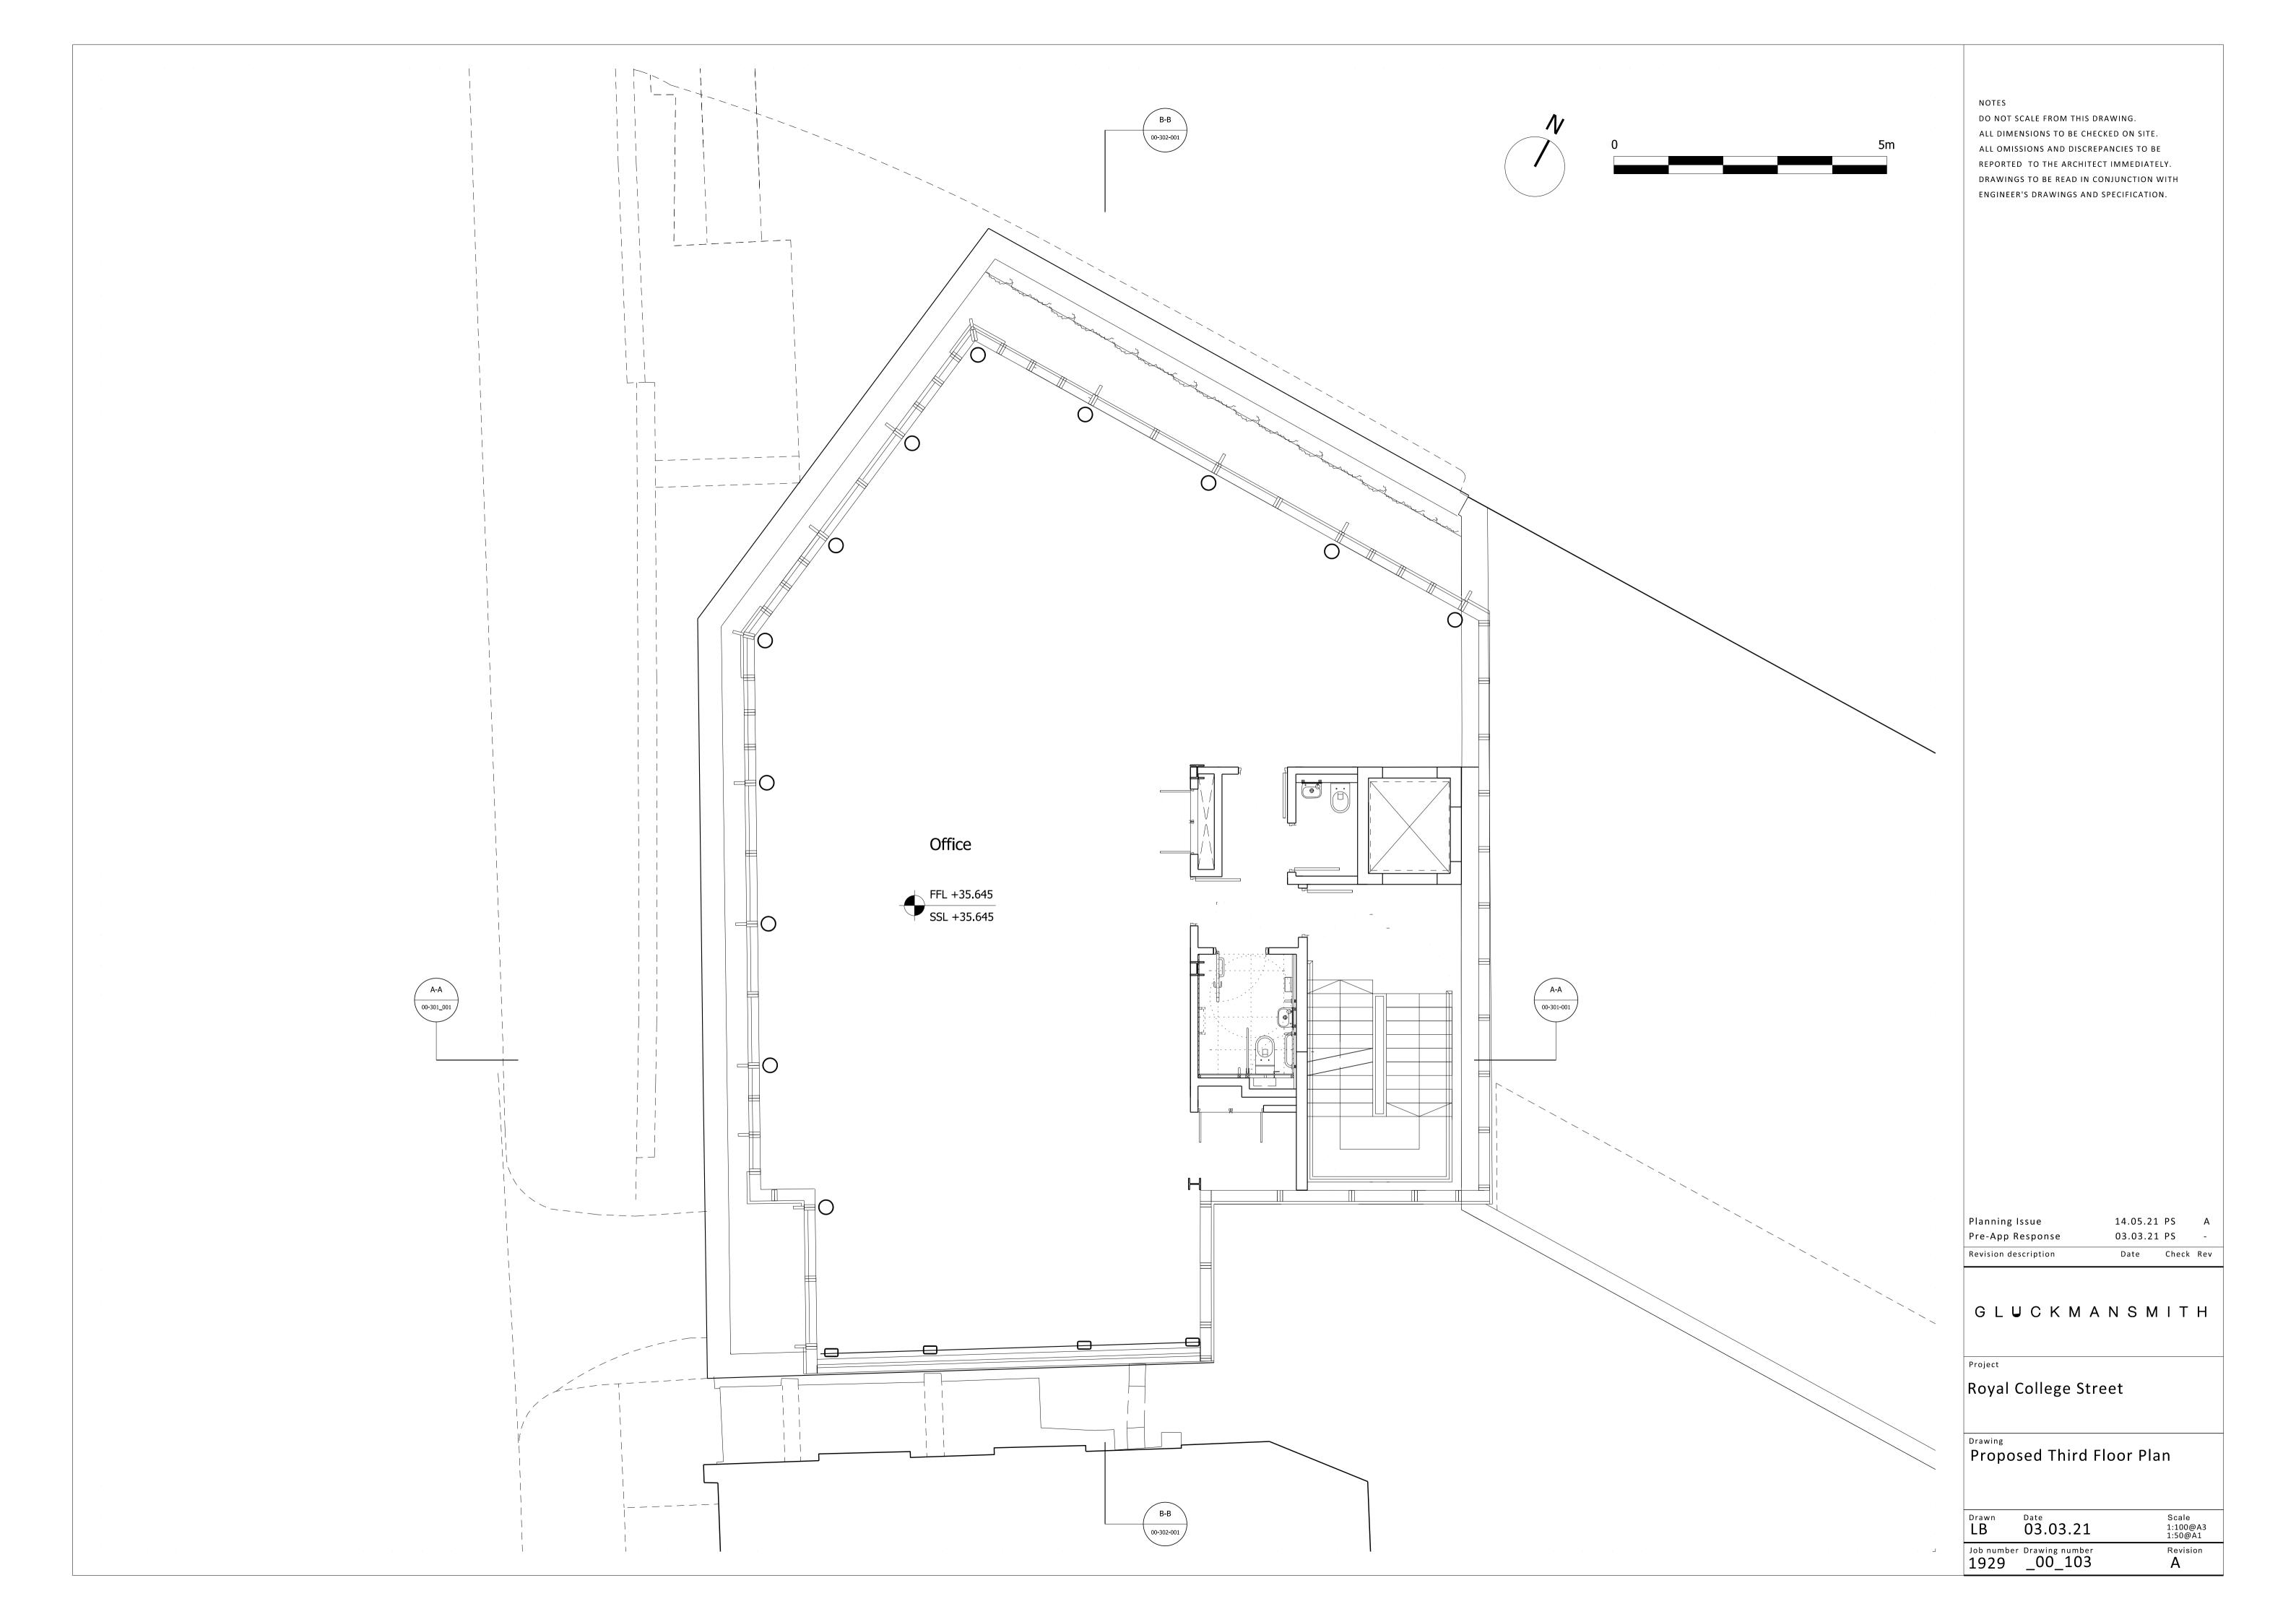










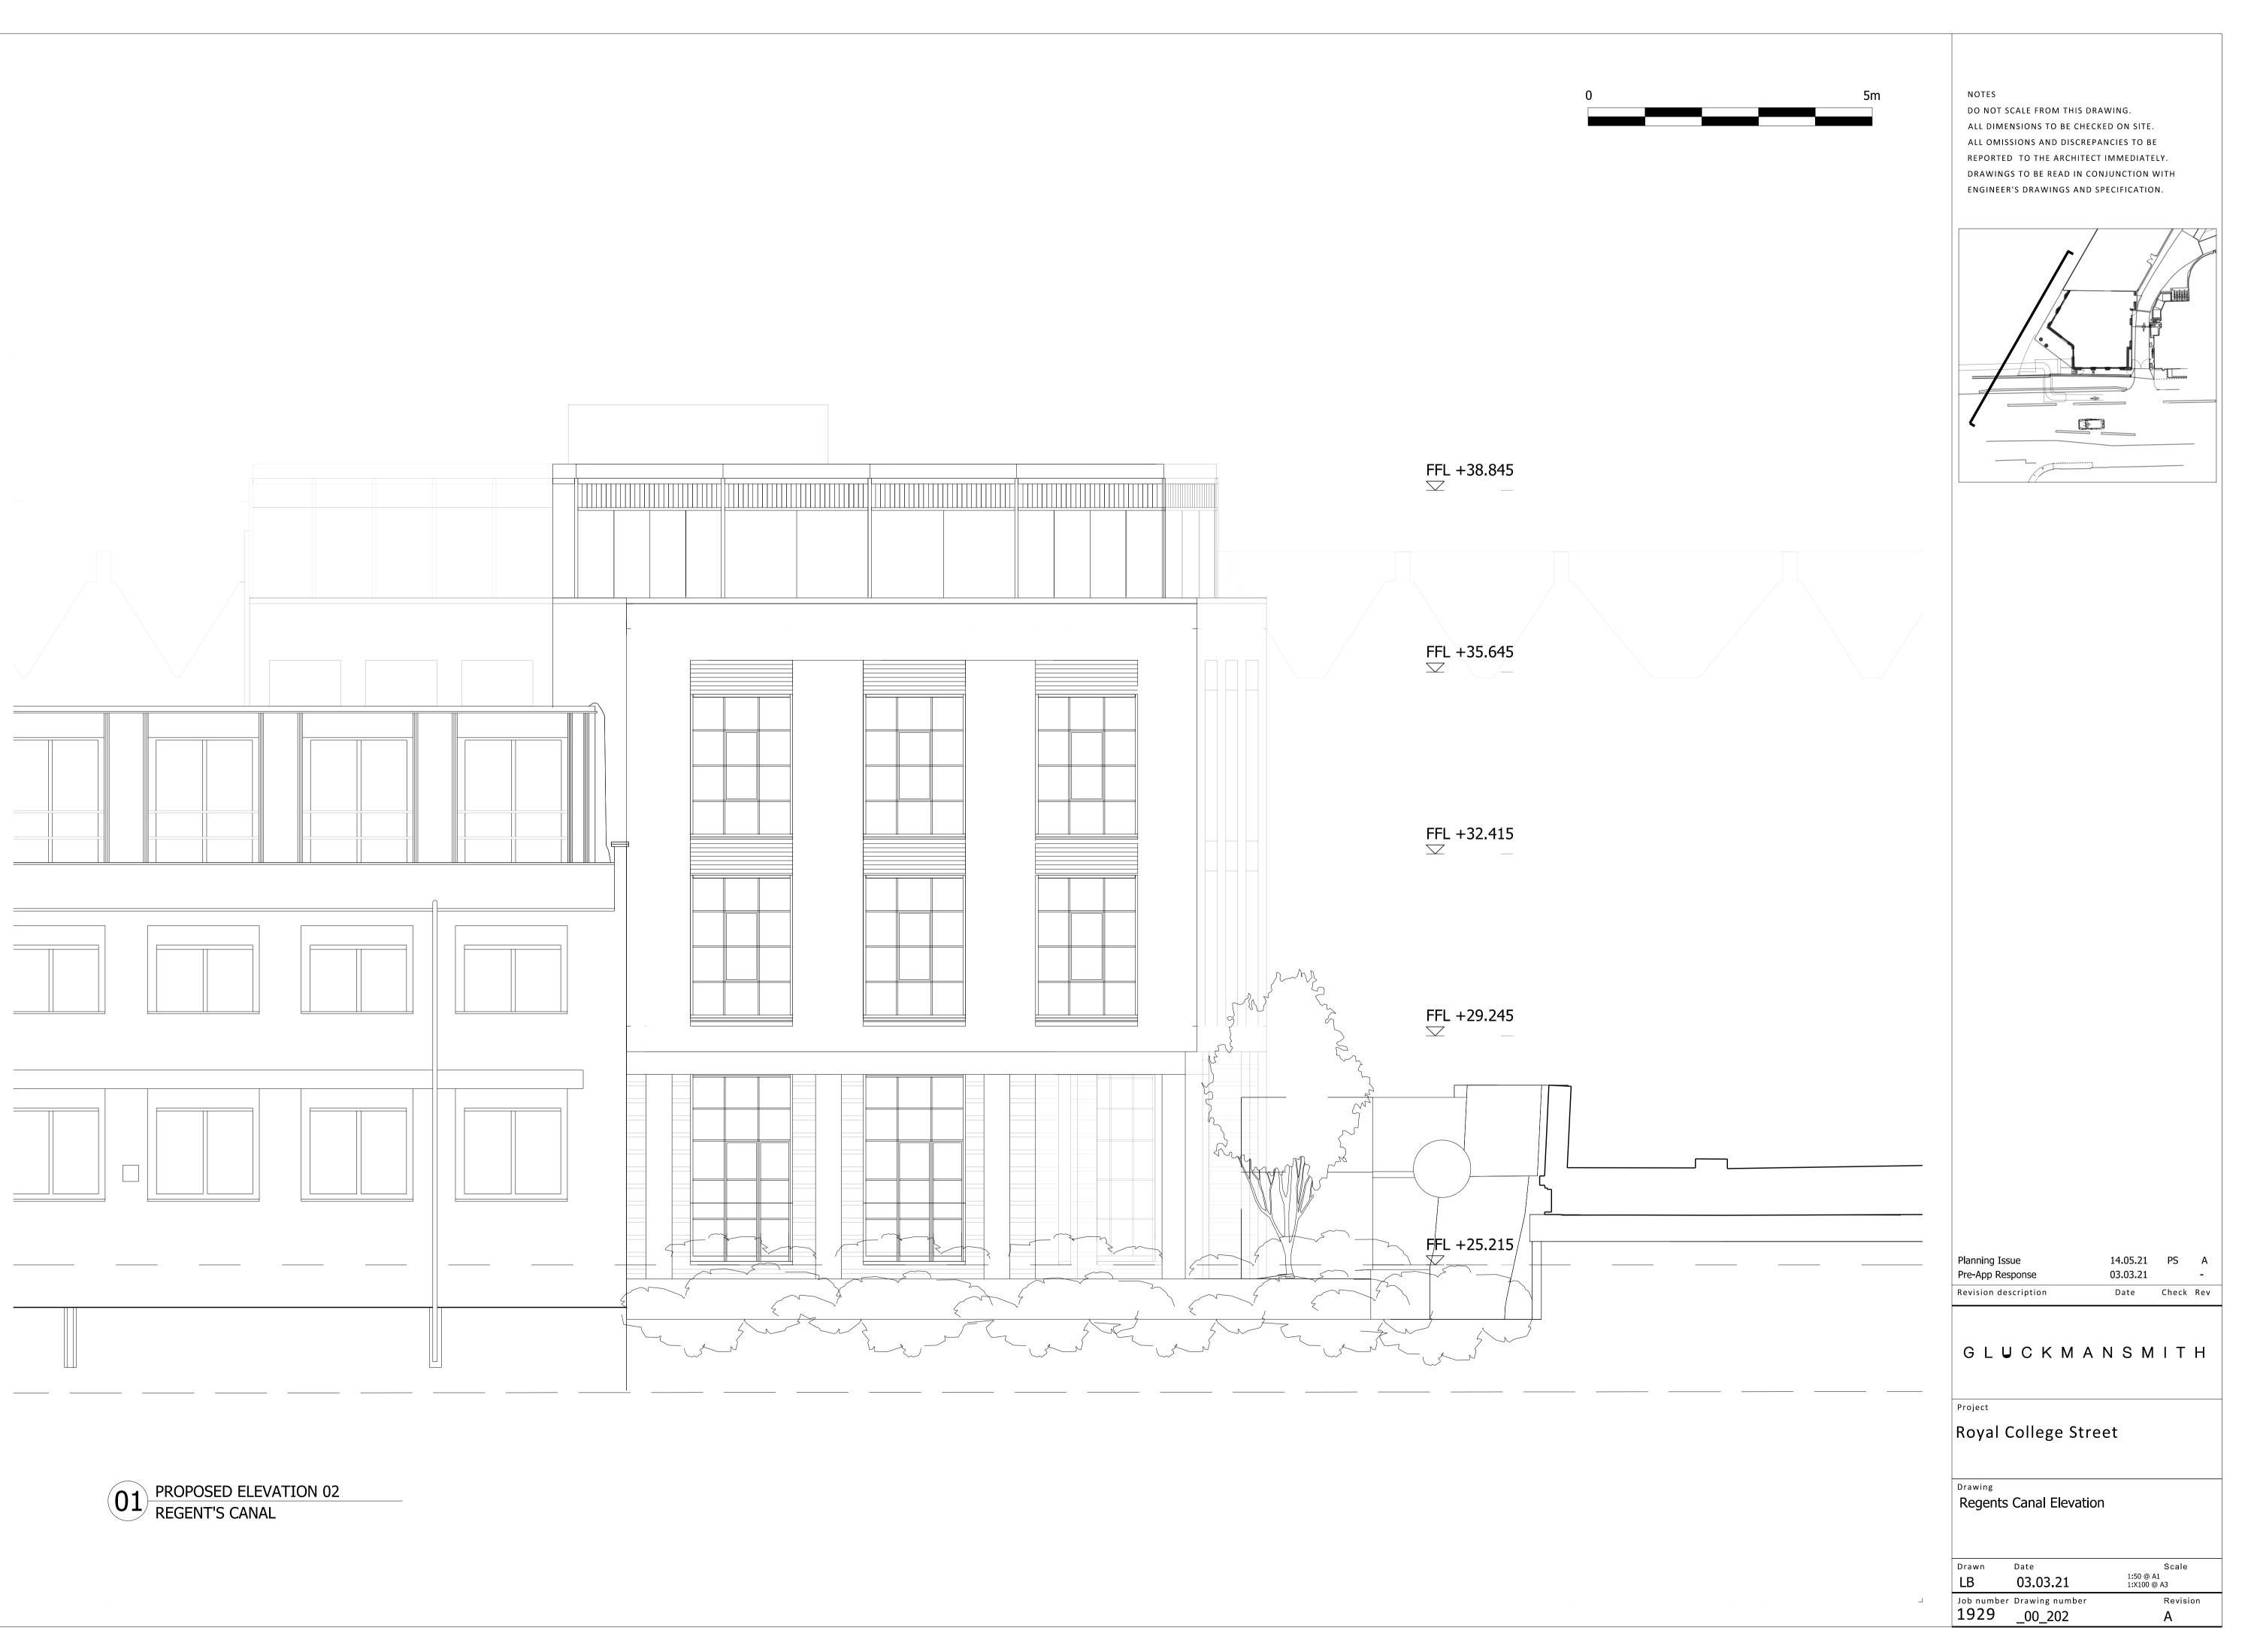


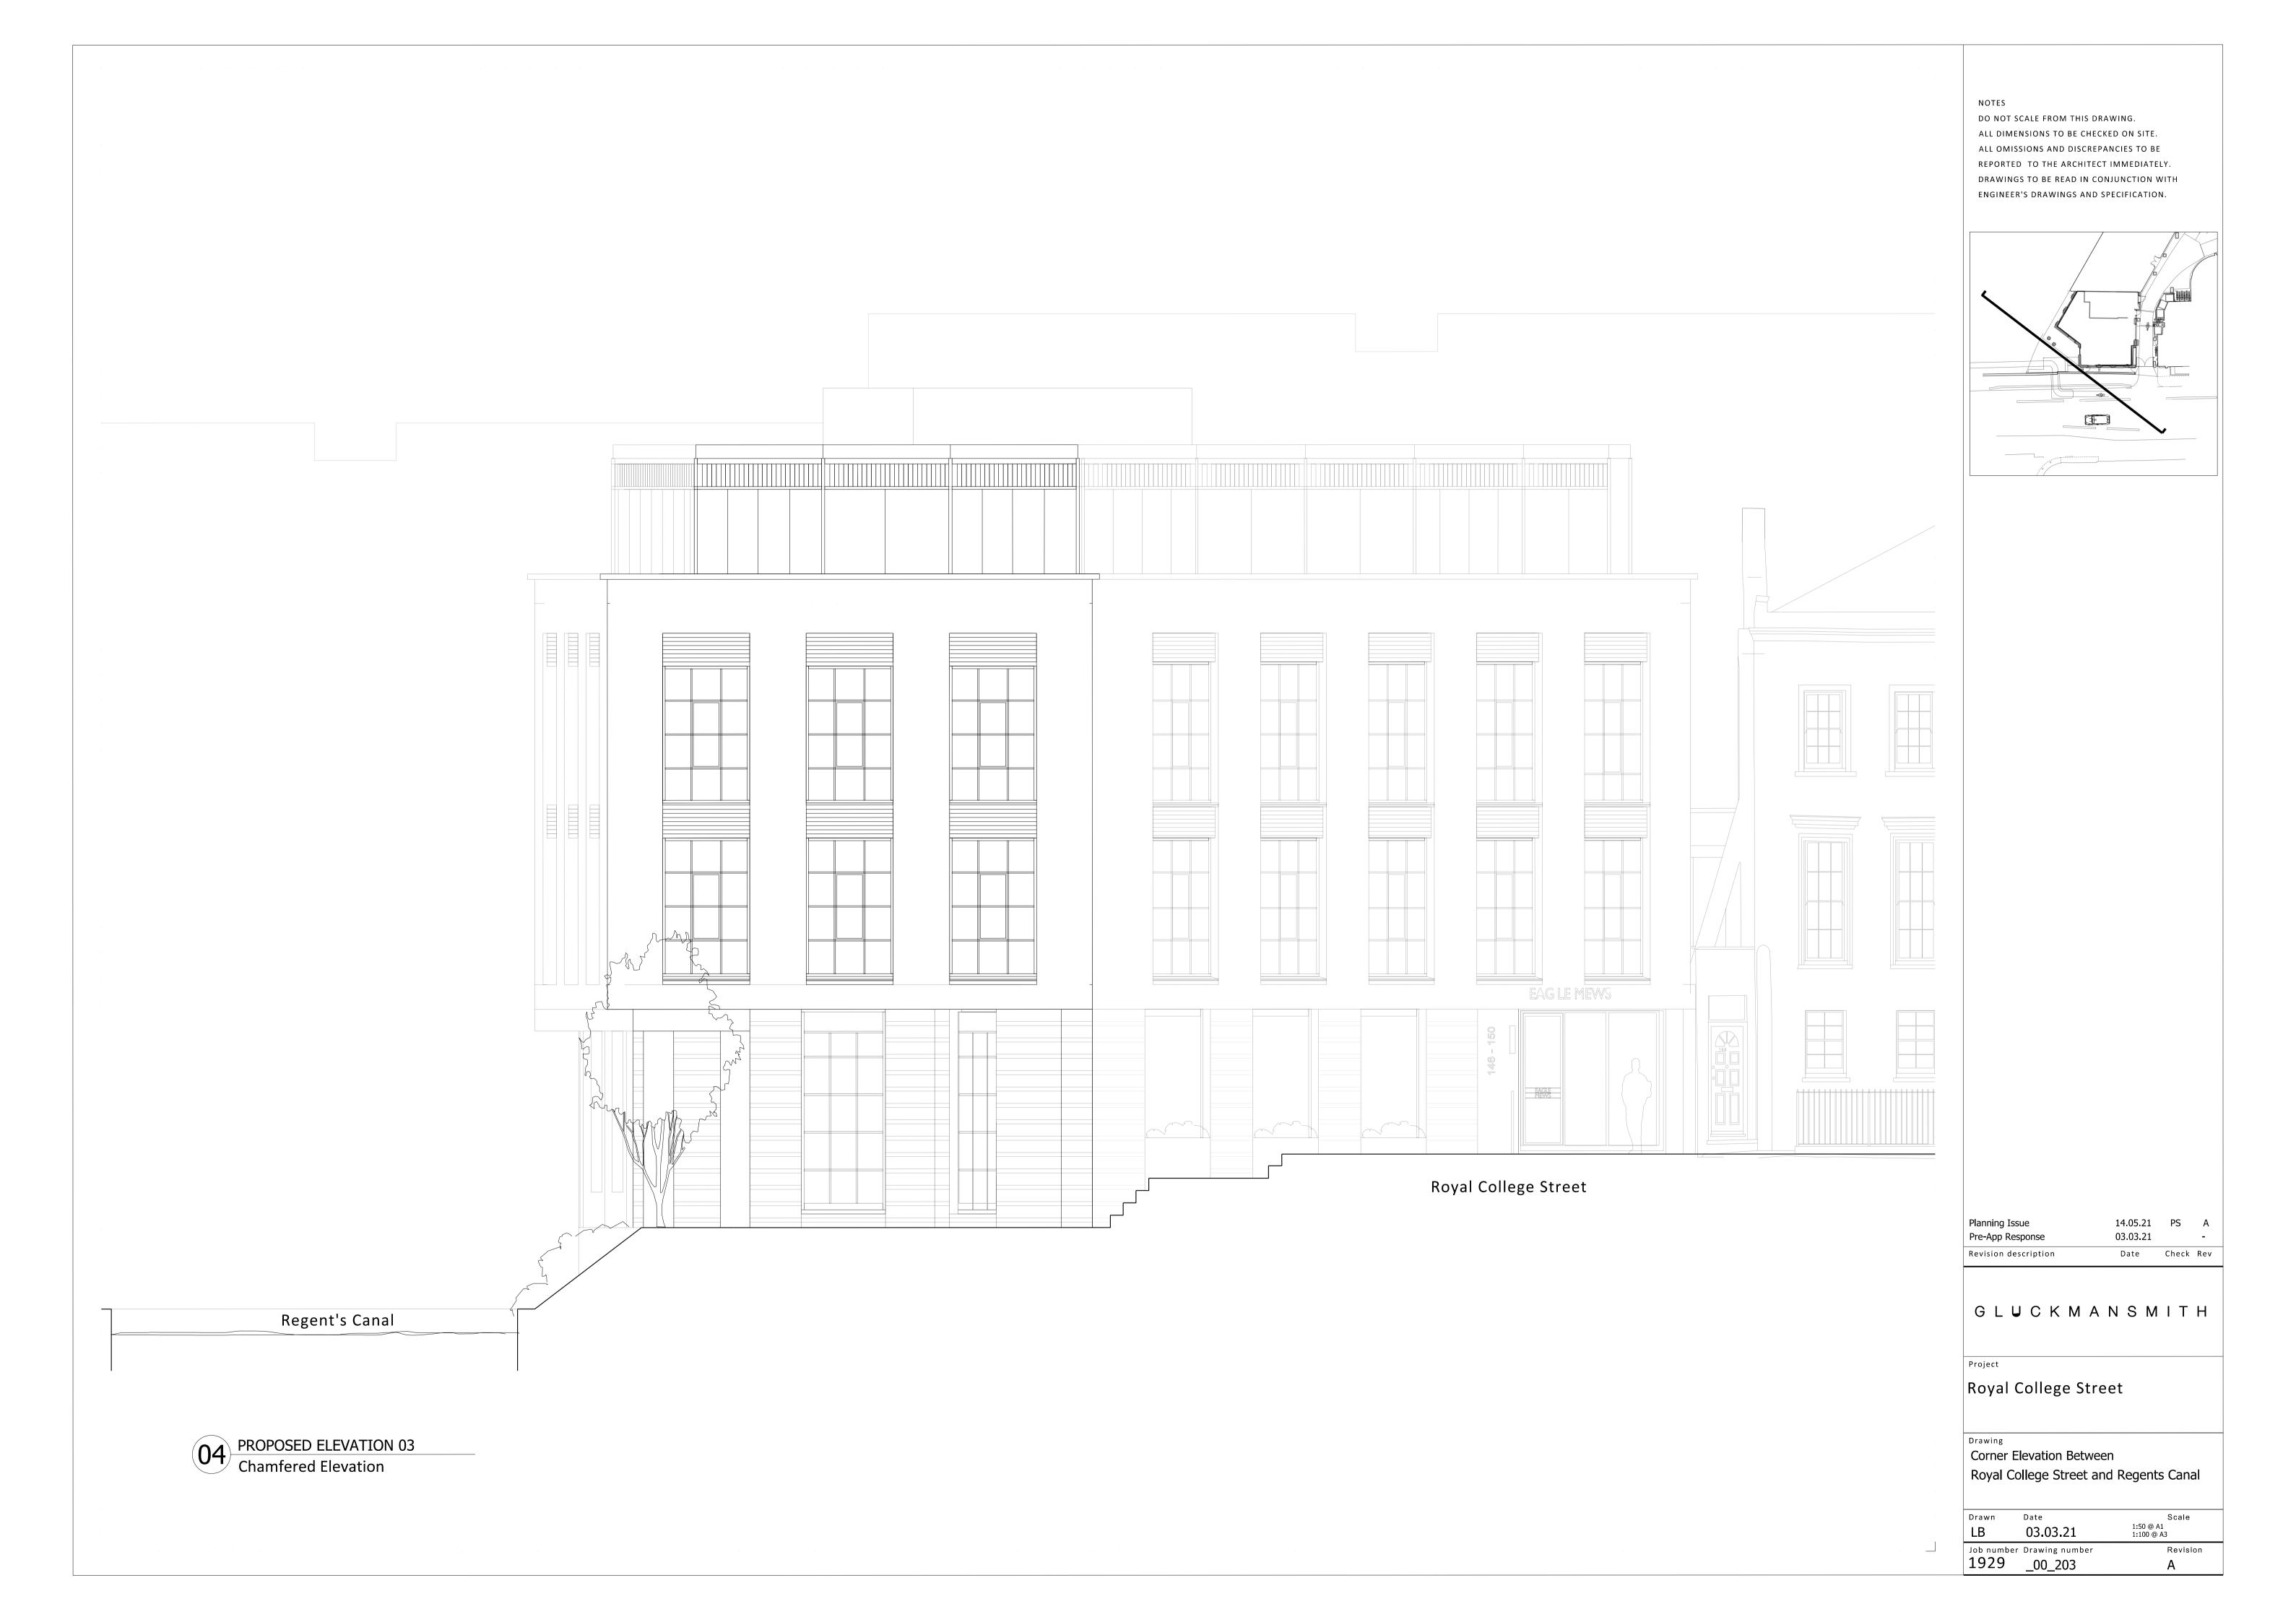

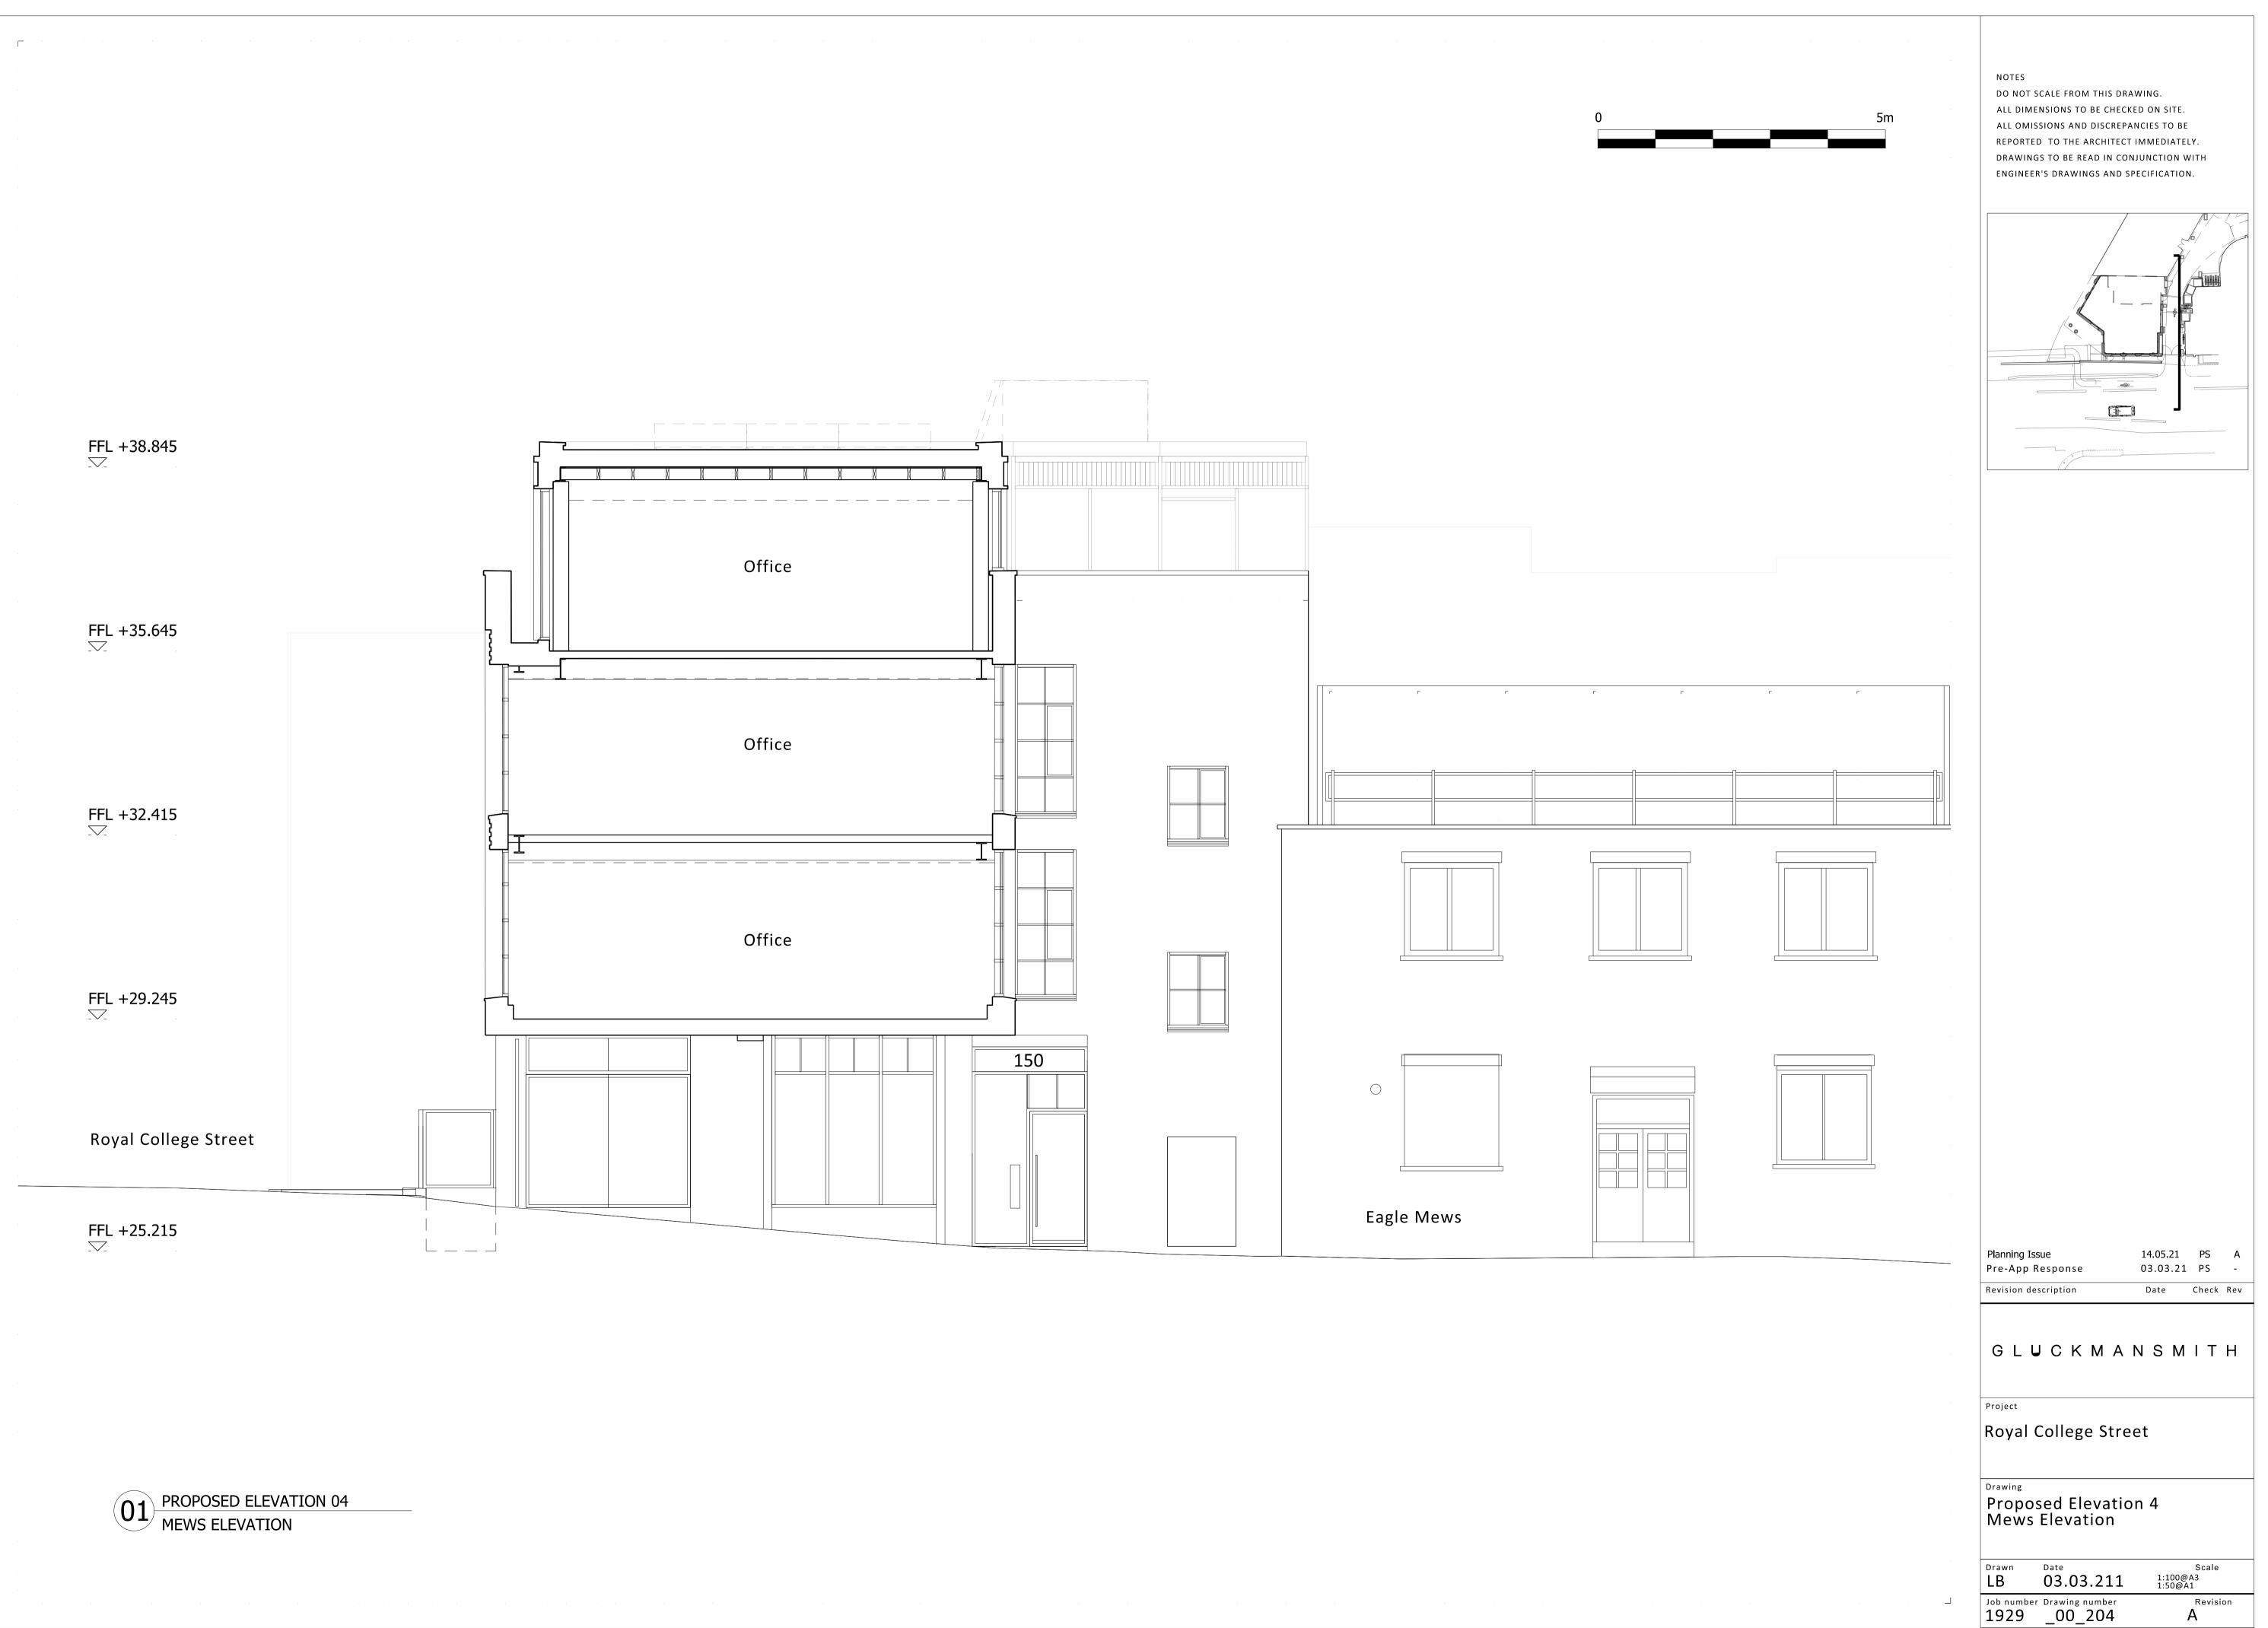

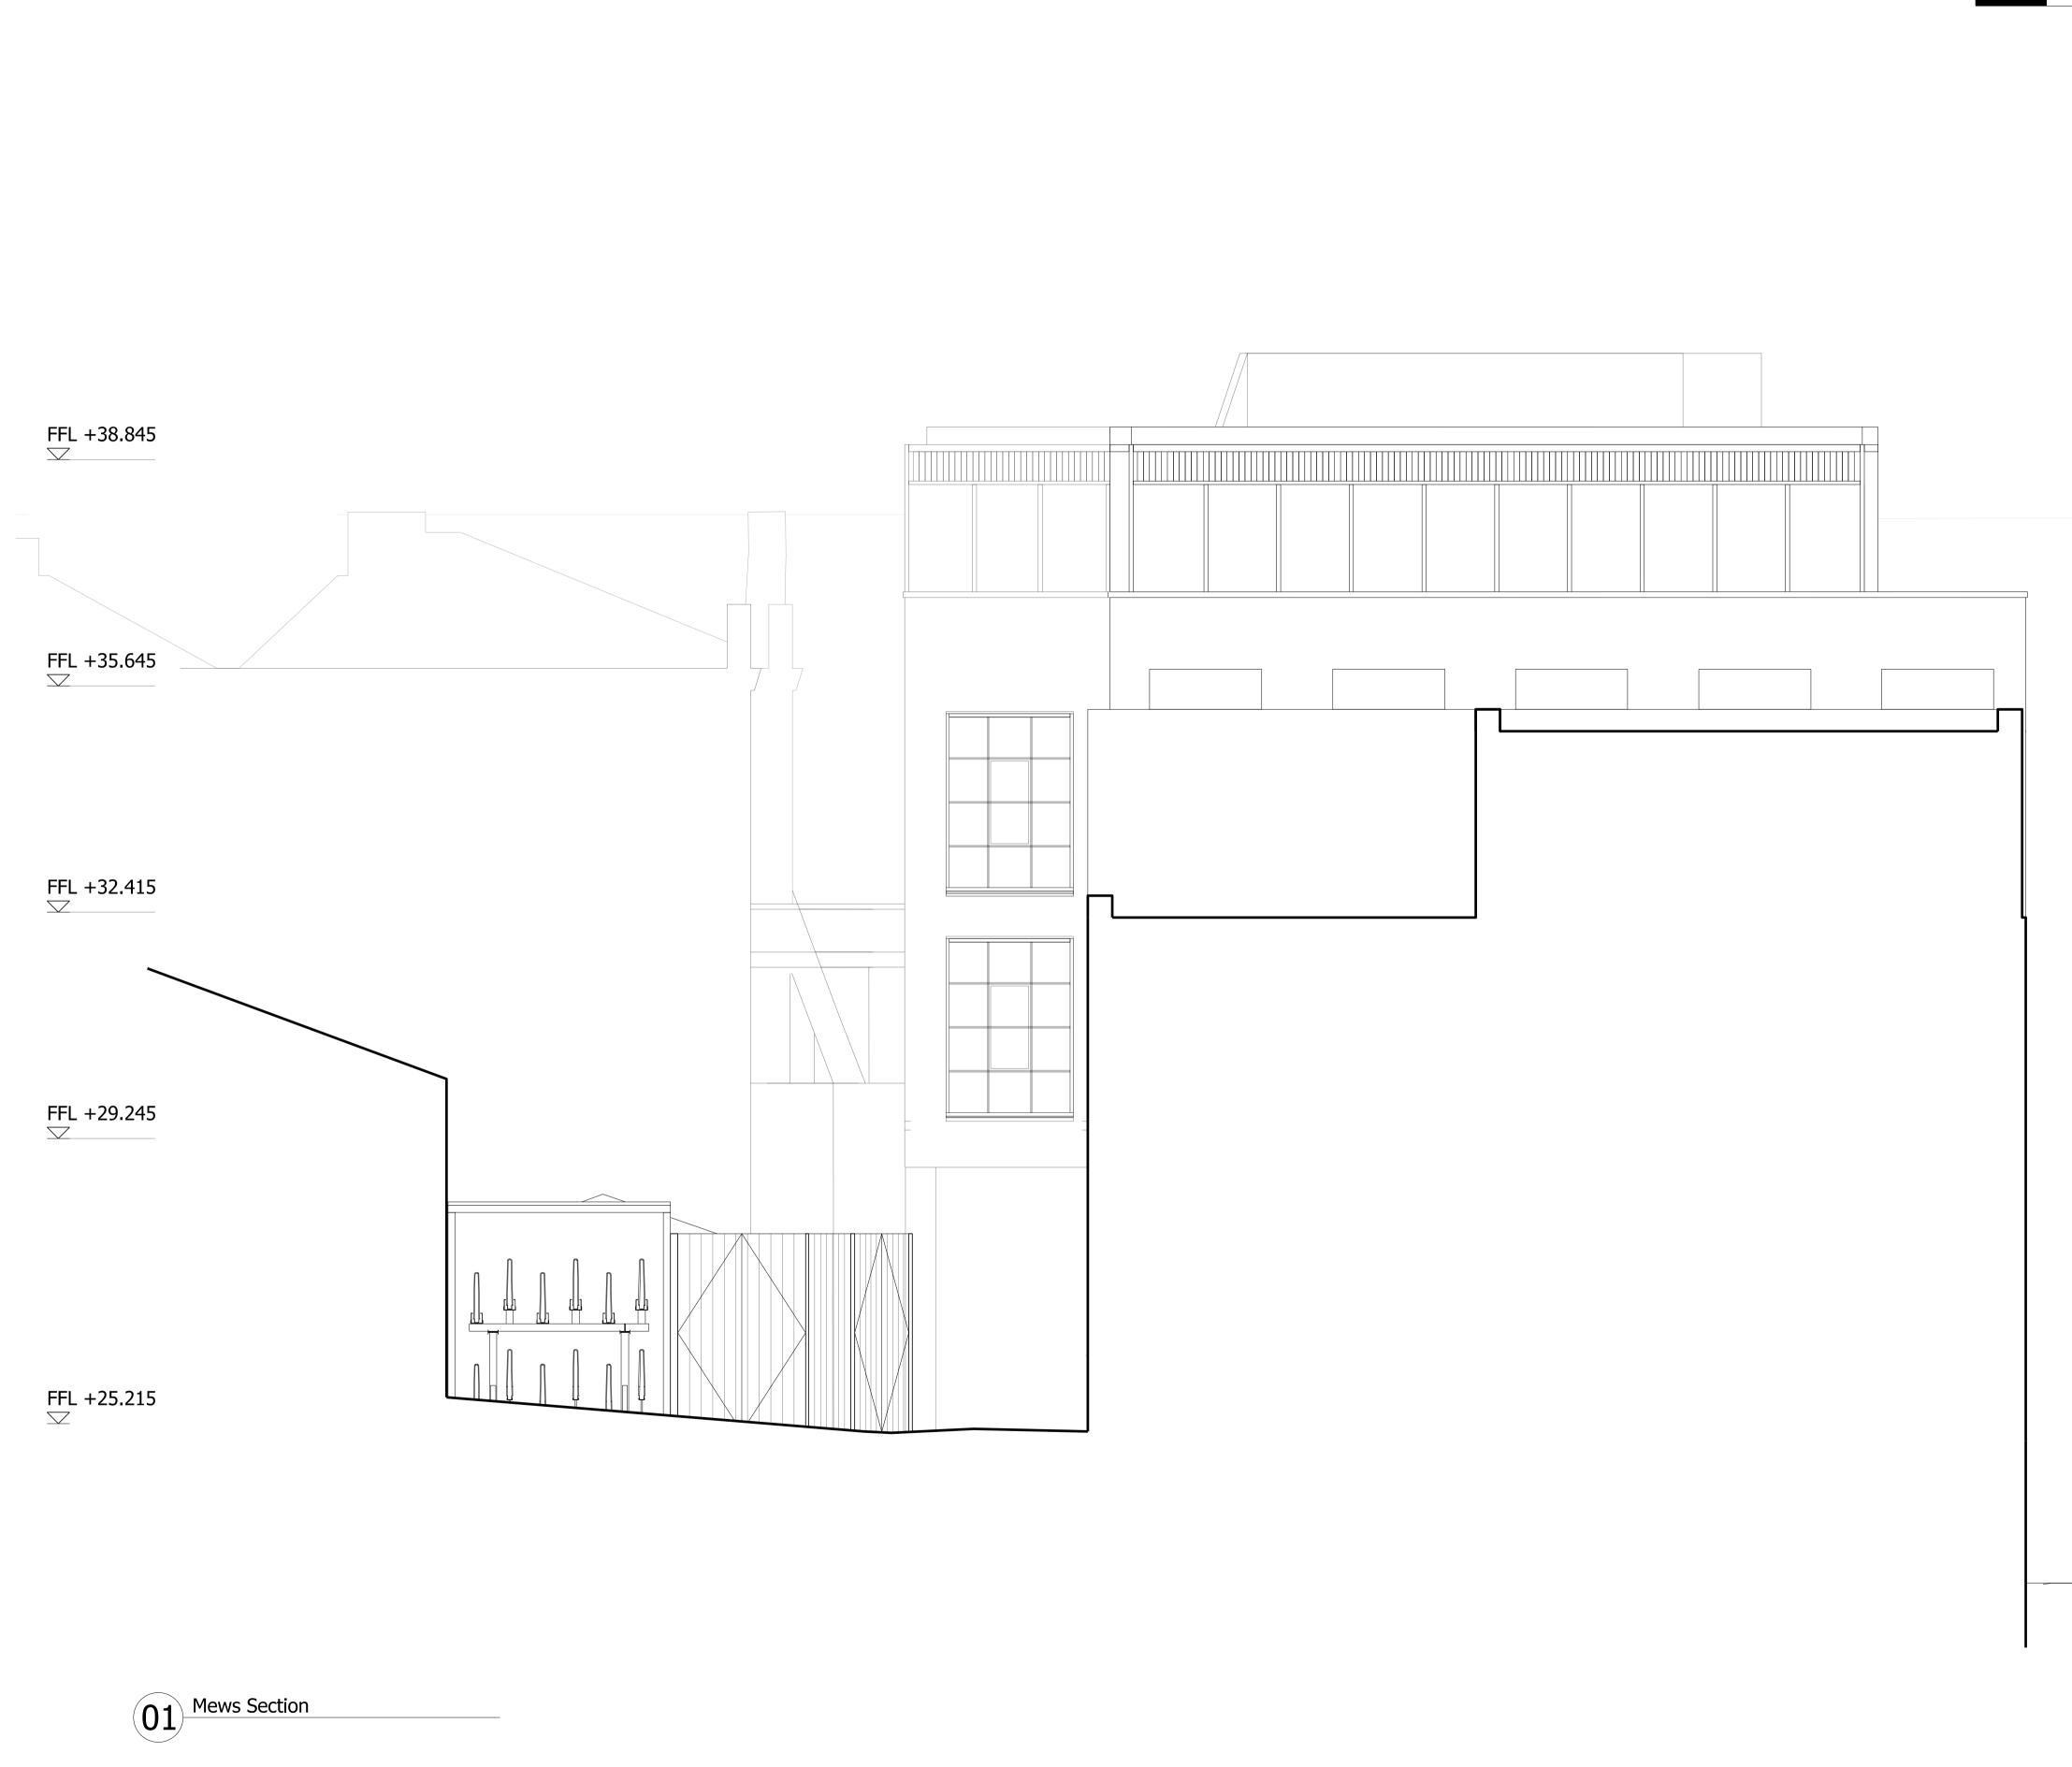

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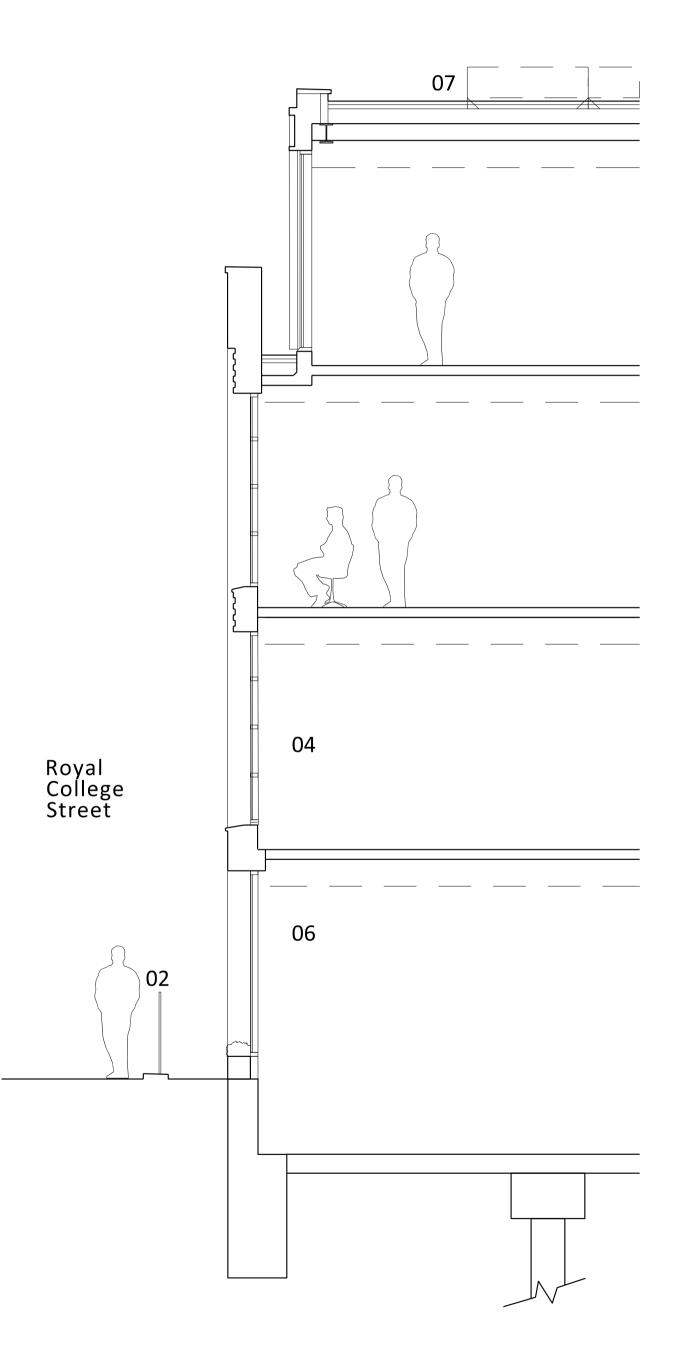
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PROPOSED ELEVATION 01 ROYAL COLLEGE STREET

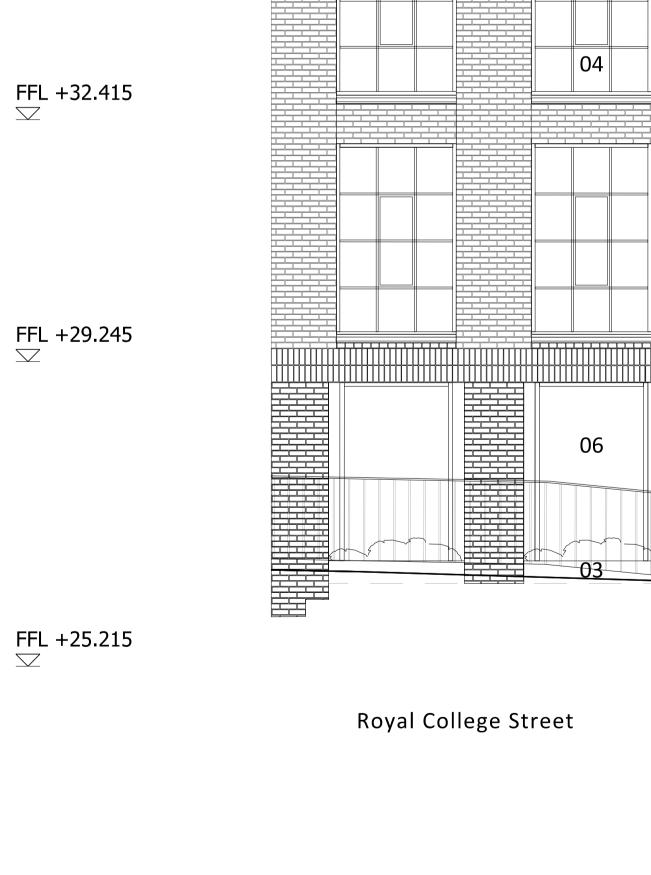


- KEY
- 01 02
- BRICK METAL BALUSTRADE / HANDRAIL

- METAL BALUSTRADE / HANDRAIL METAL PLANTER METAL FRAMED GLAZING METAL FRAMED GLAZED DOOR J6 METAL FRAMED GLAZED WINDOWS 07 GREEN ROOF 08 METAL PANEL(S) 09 METAL CLADDING 10 METAL LOUVRE PLANT SCREEN

PROPOSED SECTION 01 2 PROPOSED SECTION 01 ROYAL COLLEGE STREET


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Pre-App Response Issued for Stage 3 Pre-App Response Pre-App Meeting Revision description	03.03.21 PS 29.01.21 PS 13.08.20 PS 12.11.19 PS Date Check	C B A -
Pre-App Response Issued for Stage 3 Pre-App Response Pre-App Meeting	03.03.21 PS 29.01.21 PS 13.08.20 PS 12.11.19 PS Date Check	C B A -
Pre-App Response Issued for Stage 3 Pre-App Response Pre-App Meeting Revision description	03.03.21 PS 29.01.21 PS 13.08.20 PS 12.11.19 PS Date Check	C B A -
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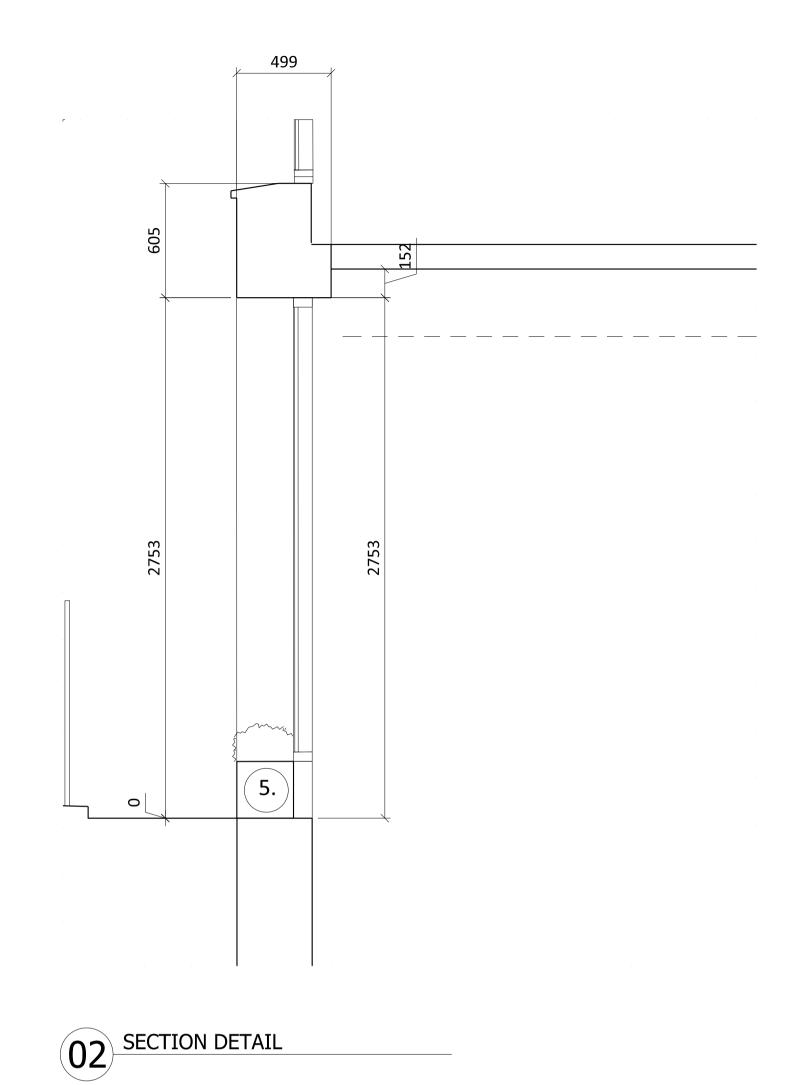


01 ELEVATION BAY STUDY DETAIL

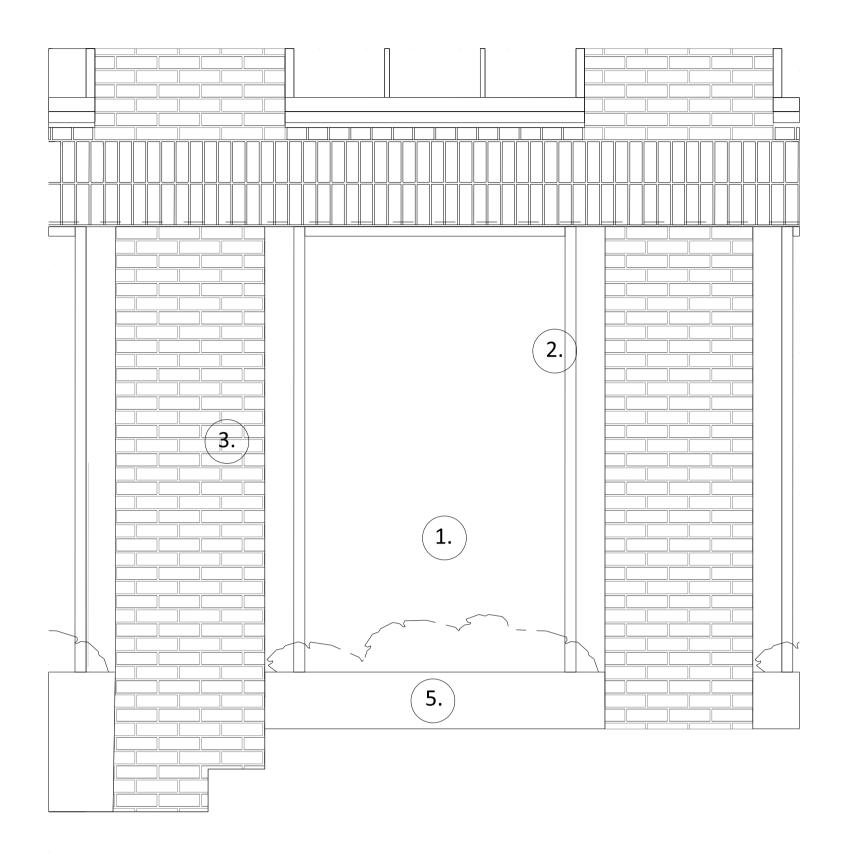
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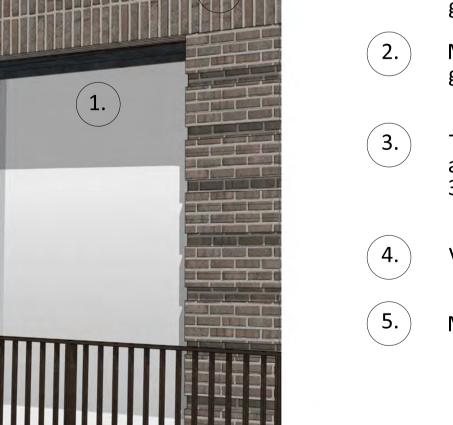


03 PLAN DETAIL



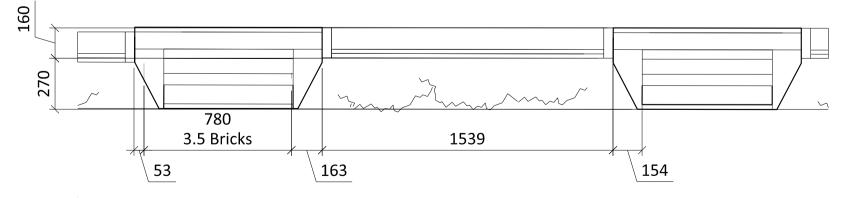



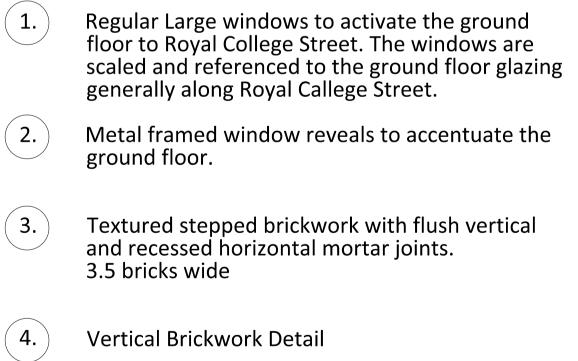

- Metal Planter




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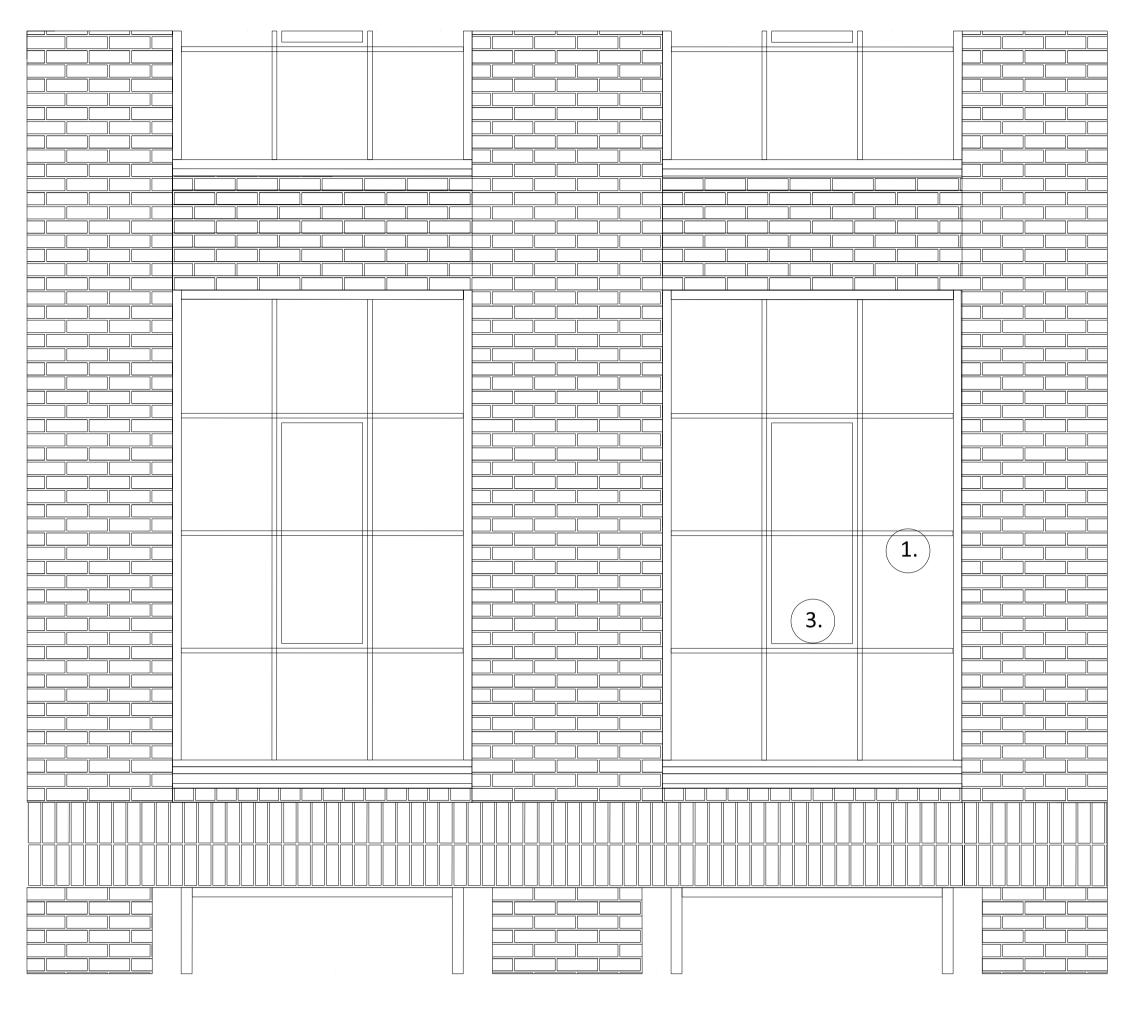
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Royal College Stre	eet		
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Drawn Date D7.01.20	1:40@A 1:20@A		
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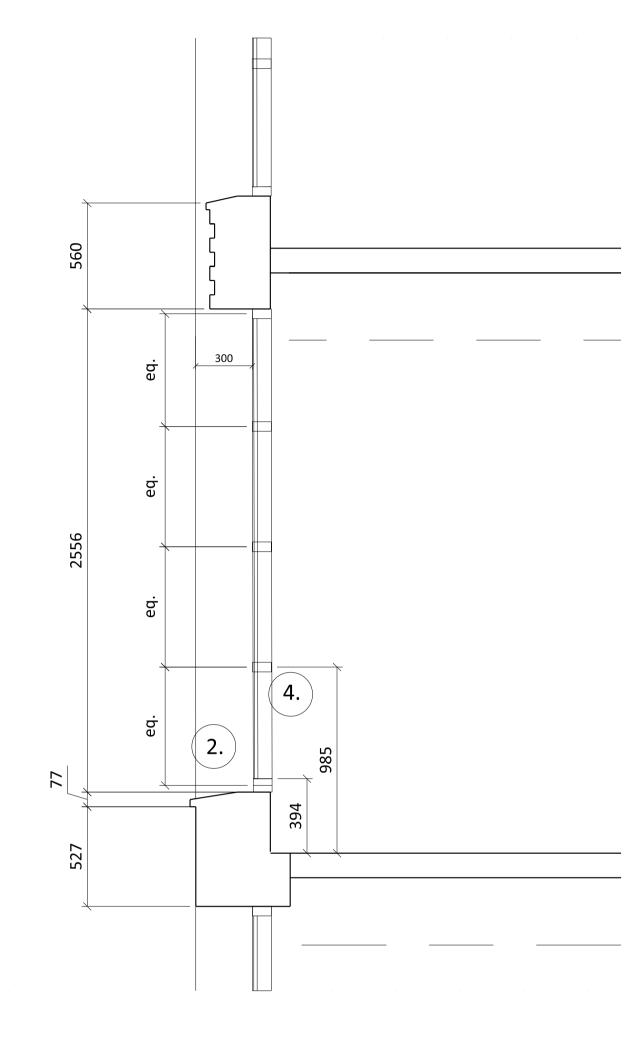
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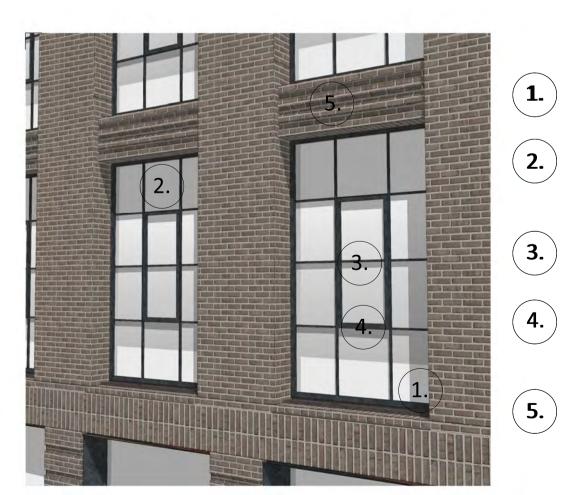


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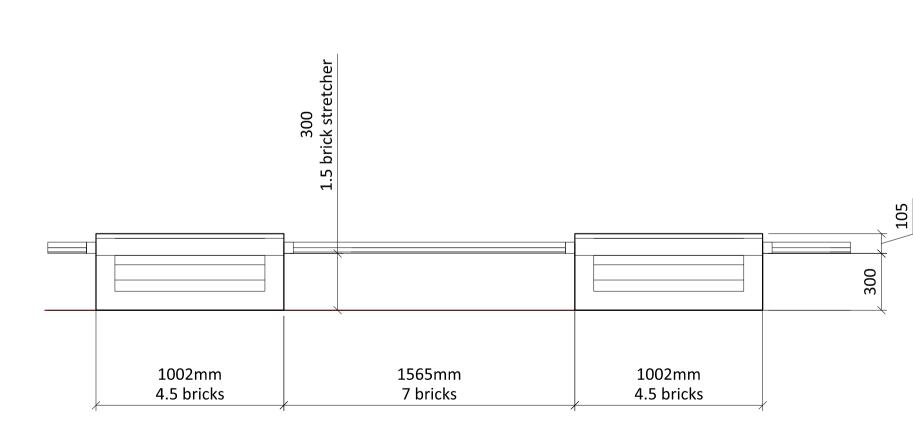
- Regular Large windows have a 365mm upstand above the floor to hide internal clutter.
- Regular framed window panes, 1.5 m by 2.4 m high, are inset the length of a brick from the face of the brick wall.
- The opening pane is set centrally, giving an articulation of interest to the elevation.
- A transom at 900 mm above FFL provides a comfortable feeling of security when the window is open.
- Textured stepped brickwork spandrel with flush vertical and recessed horizontal mortar joints. Brick sill and window head to be brick specials

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Planning Issue	11.03.21 13
Planning Issue Issued for Stage 3 Pre-App Response	29.01.21 PS 07.01.20 PS


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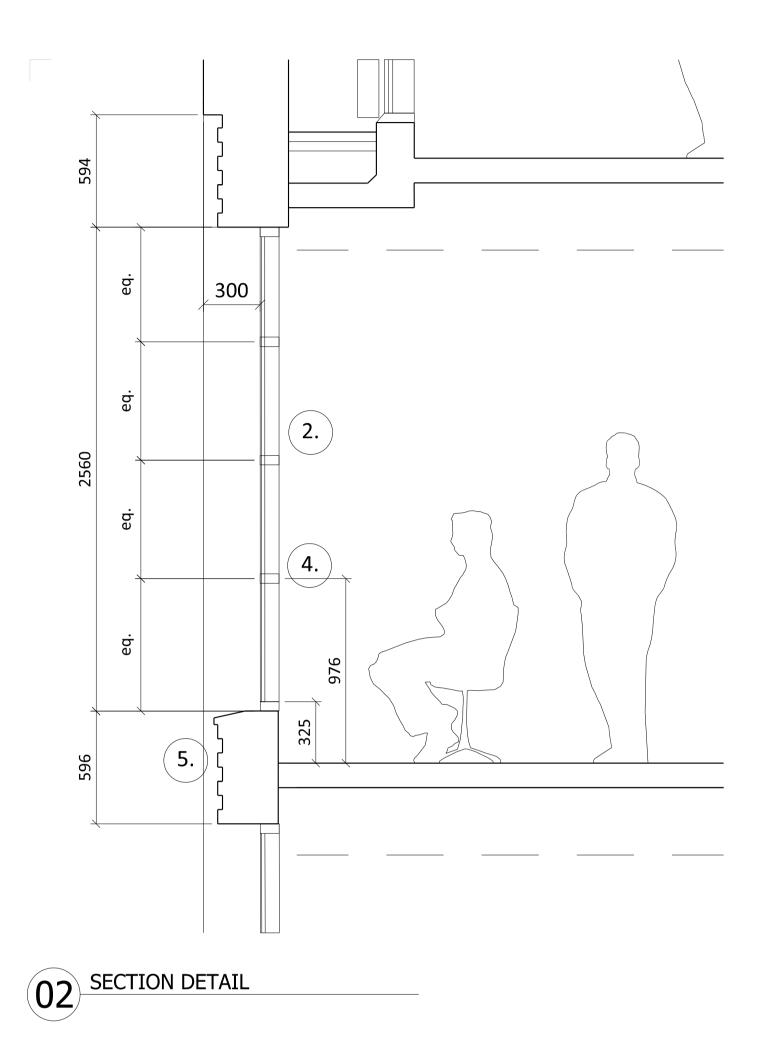
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- Regular Large windows have a 365mm upstand above the floor to hide internal clutter.
- Regular framed window panes, 1.5 m by 2.4 m high, are inset the length of a brick (215mm) from the face of the wall.
- The opening pane is set centrally, giving an articulation of interest to the elevation.
- A transom at 900 mm above FFL provides a comfortable feeling of security when the window is open.
- Textured stepped brickwork spandrel with flush vertical and recessed horizontal mortar joints. brick sills and window heads are brick specials

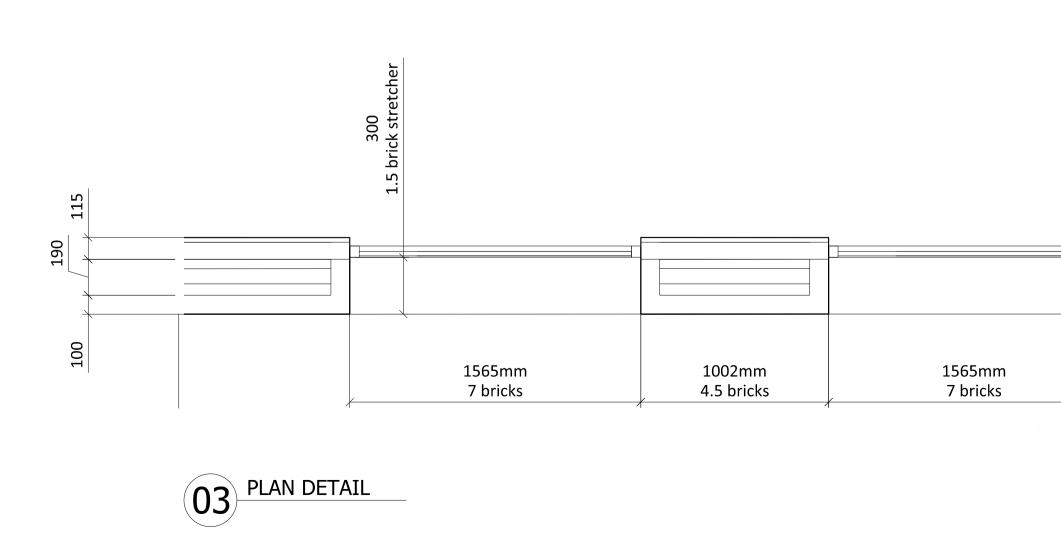



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Project


Royal College Street

Drawing Facade Detail Royal College Street Typical Windows Date 30.03.21 Drawn **PS** Scale 1:40@A3 1:20@A1 Job number Drawing number 1929 _21_201_004 Revision В

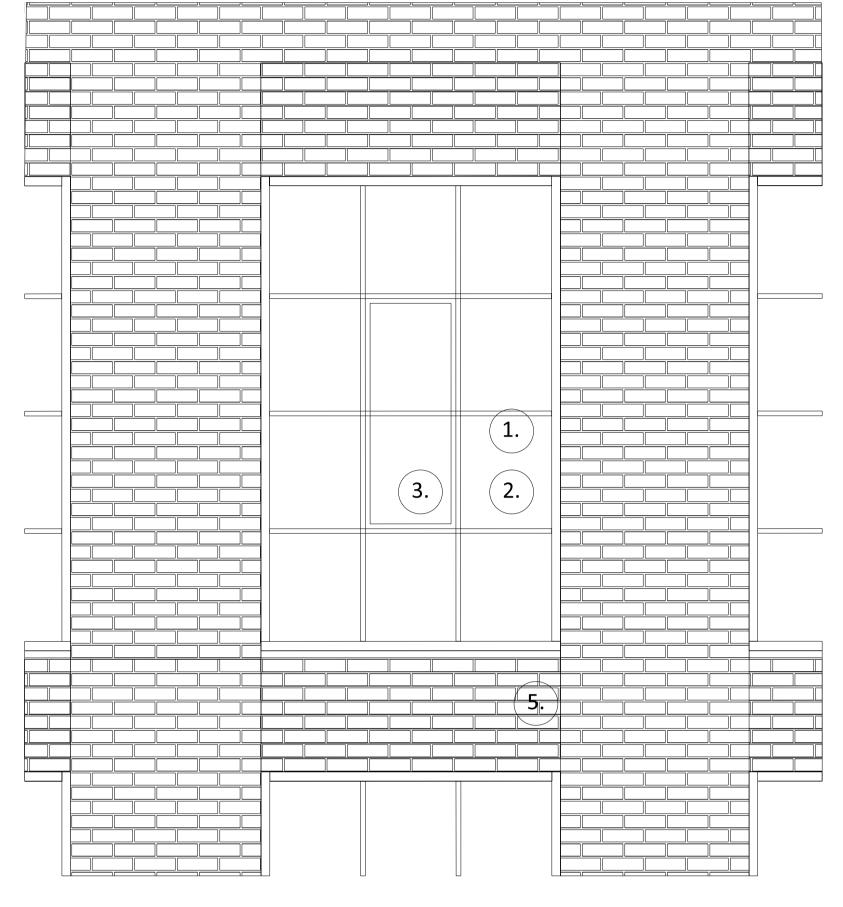

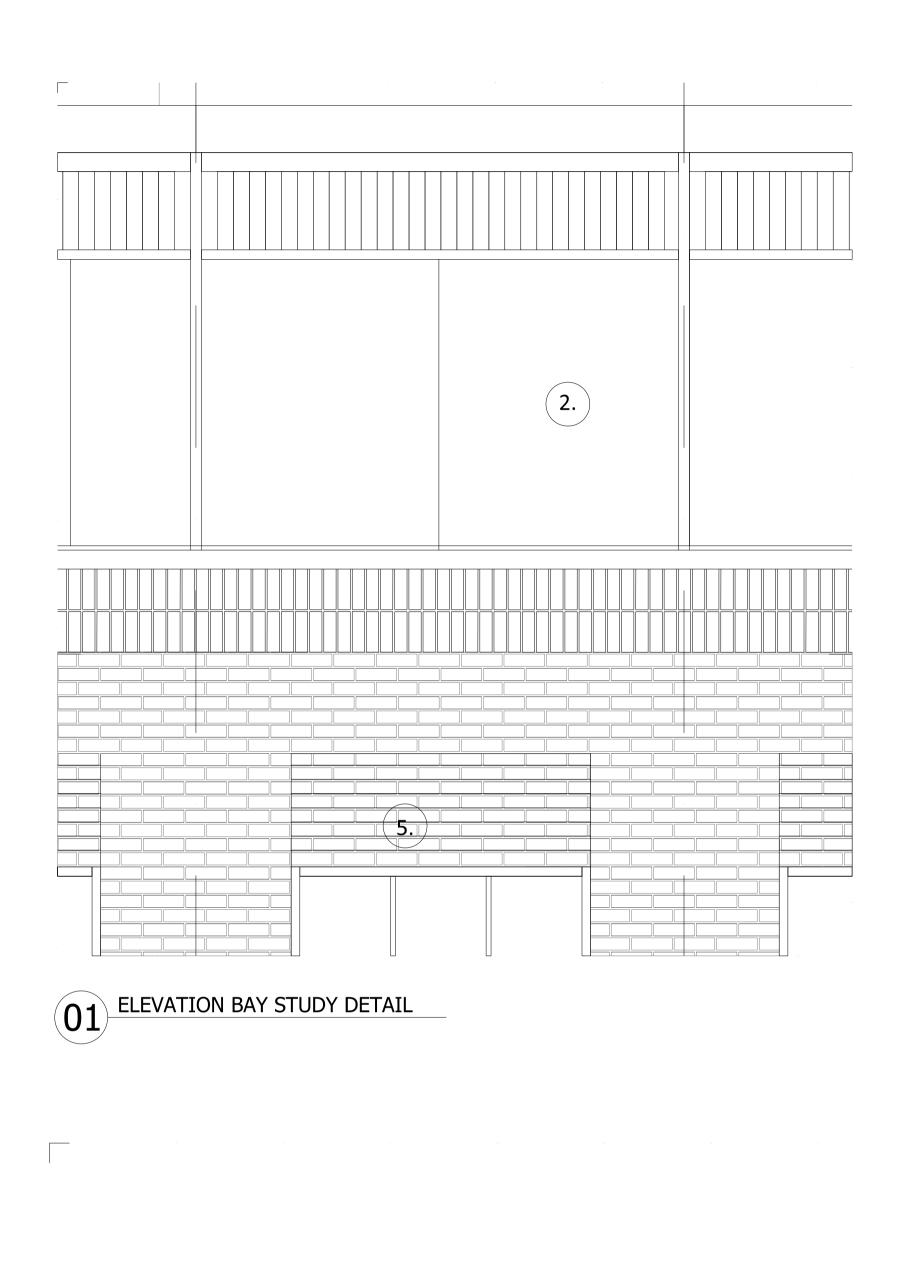

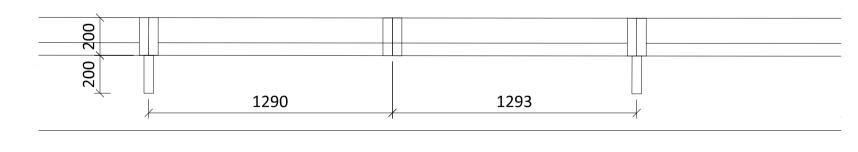03 PLAN DETAIL

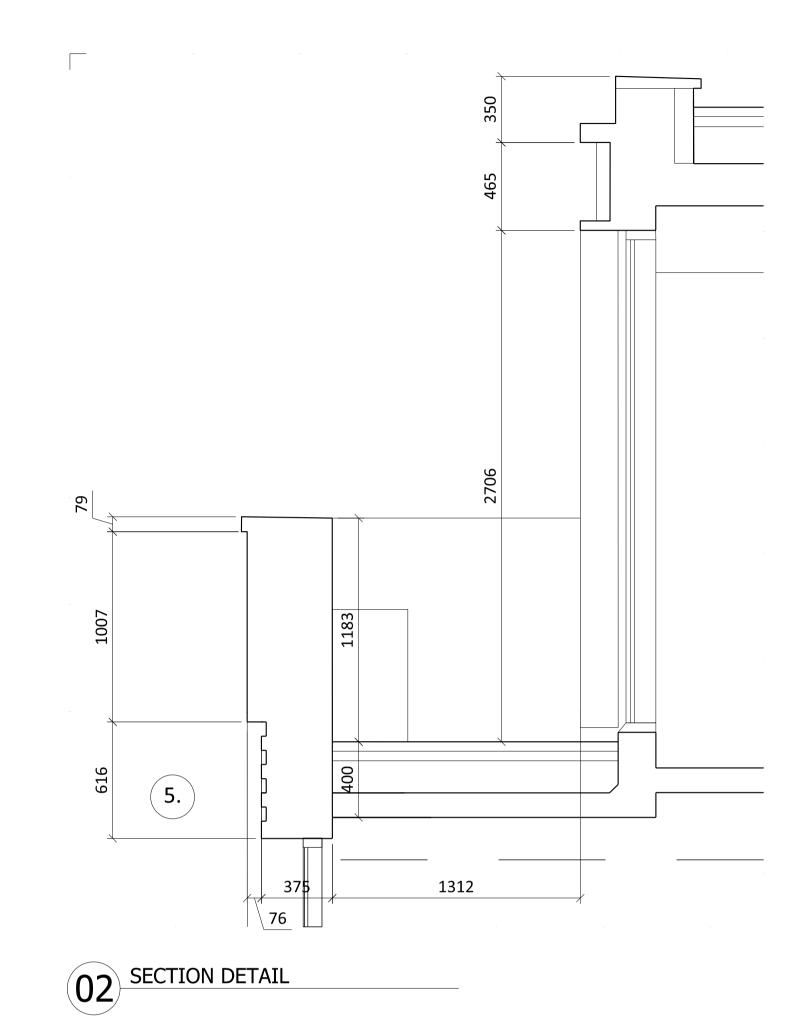



- Regular Large windows behind the raised brick upstand.
- Glazed frames within Curtain walling, full height with to access to terrace.
- Metal Coping to cap the Masonary wall
- Metal Cladding and window surrounds create a distinct and unique character to the top floor

4.

Vertical Brickwork Detail





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Project	•
150 Royal Colles	ge Street
Drawing	
Facade Detail	al Bay Windows
Top Floor Typic	

NOTES

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ALL DIMENSIONS TO BE CHECKED ON SITE.



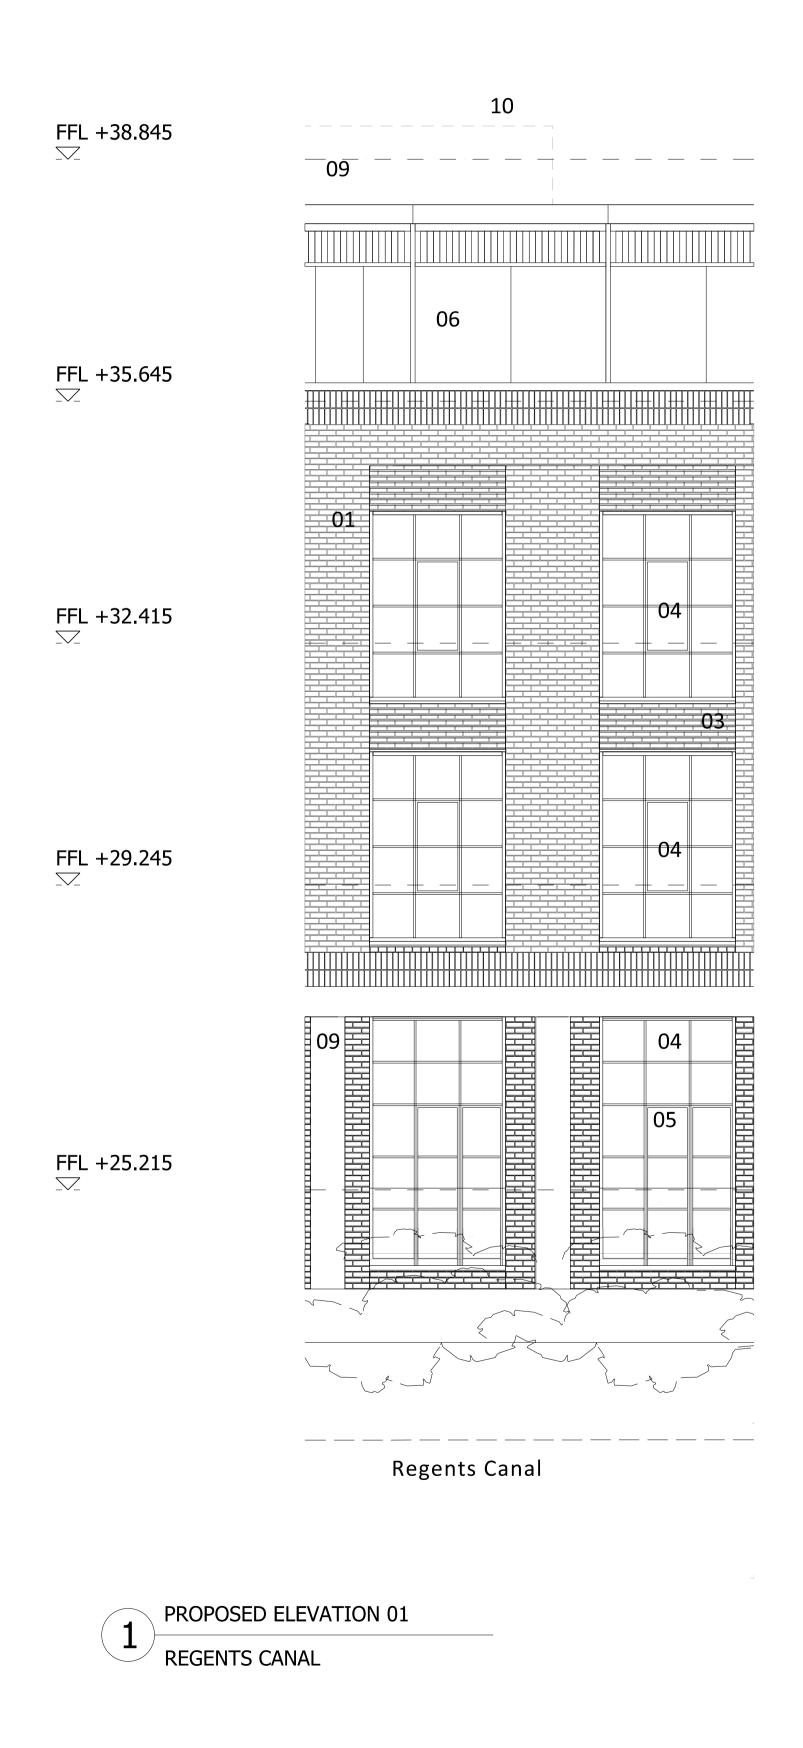

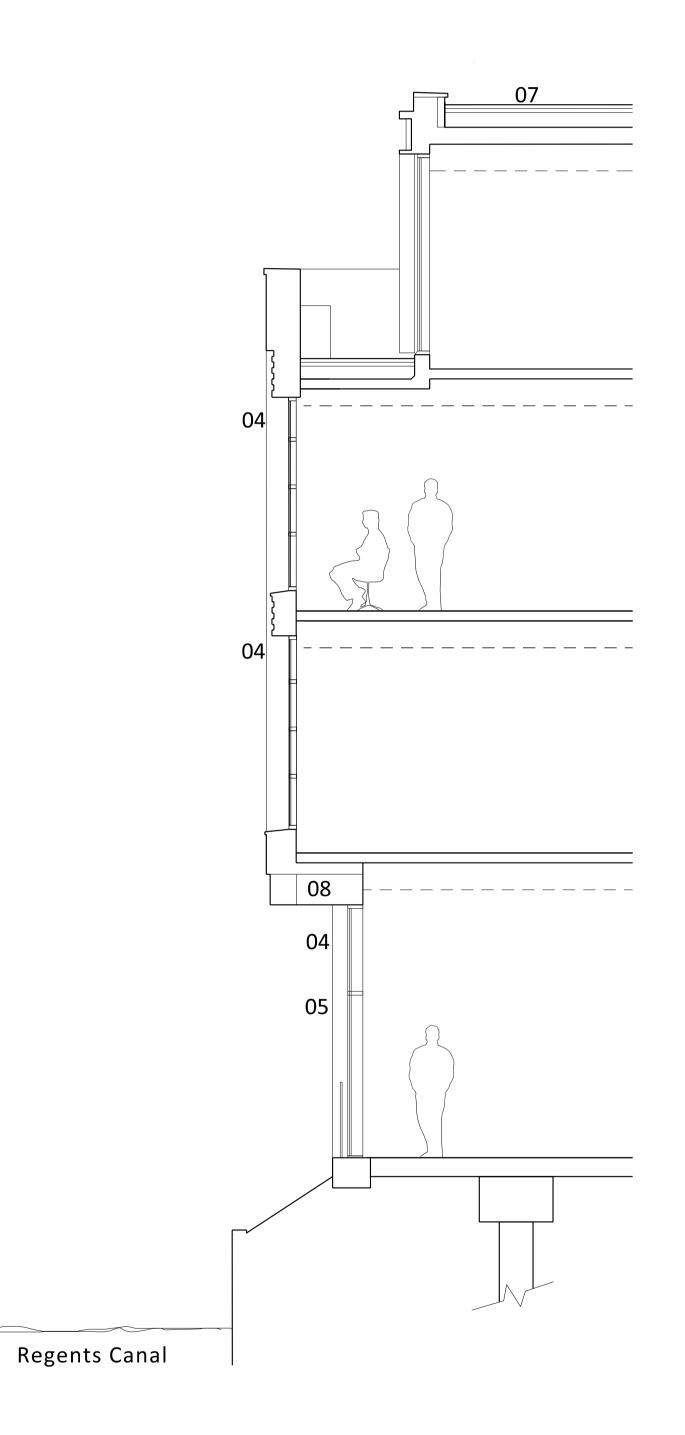KEY

01	BRICK
02	METAL BALUSTRADE / HANDRA
03	METAL PLANTER
04	METAL FRAMED GLAZING
05	METAL FRAMED GLAZED DOOR
06	METAL FRAMED GLAZED WIND
07	GREEN ROOF
08	METAL PANEL(S)
09	METAL CLADDING

10 METAL LOUVRE PLANT SCREEN


2 PROPOSED SECTION REGENTS CANAL

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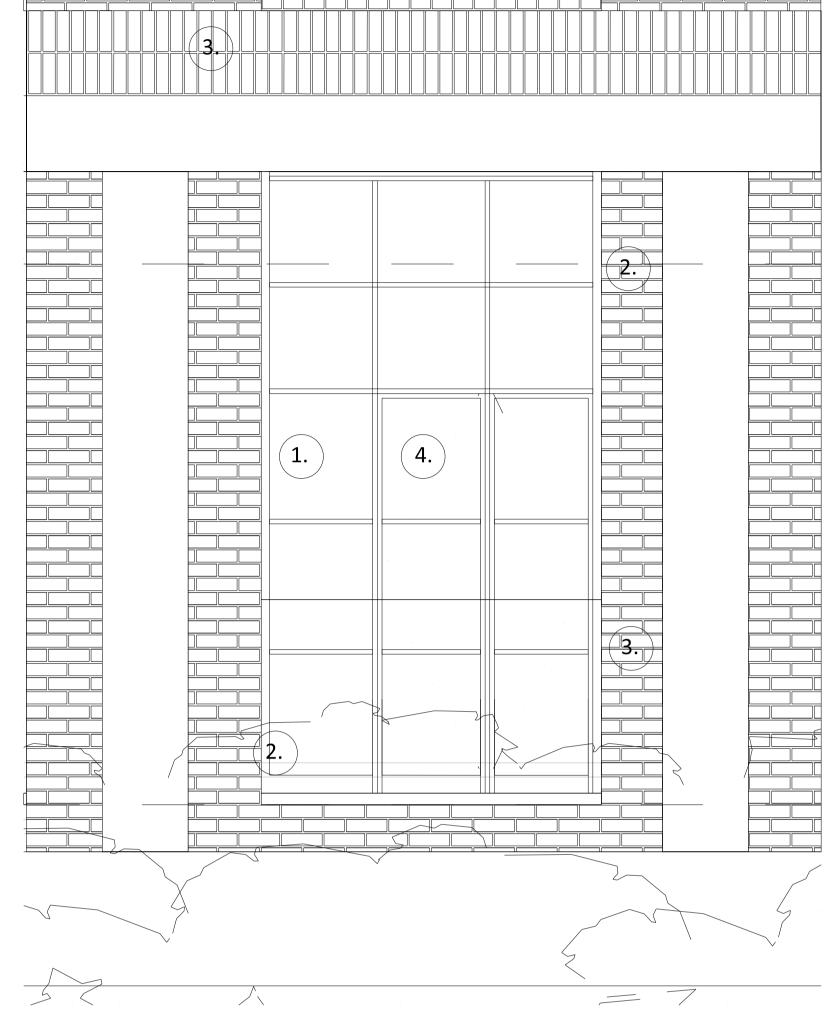
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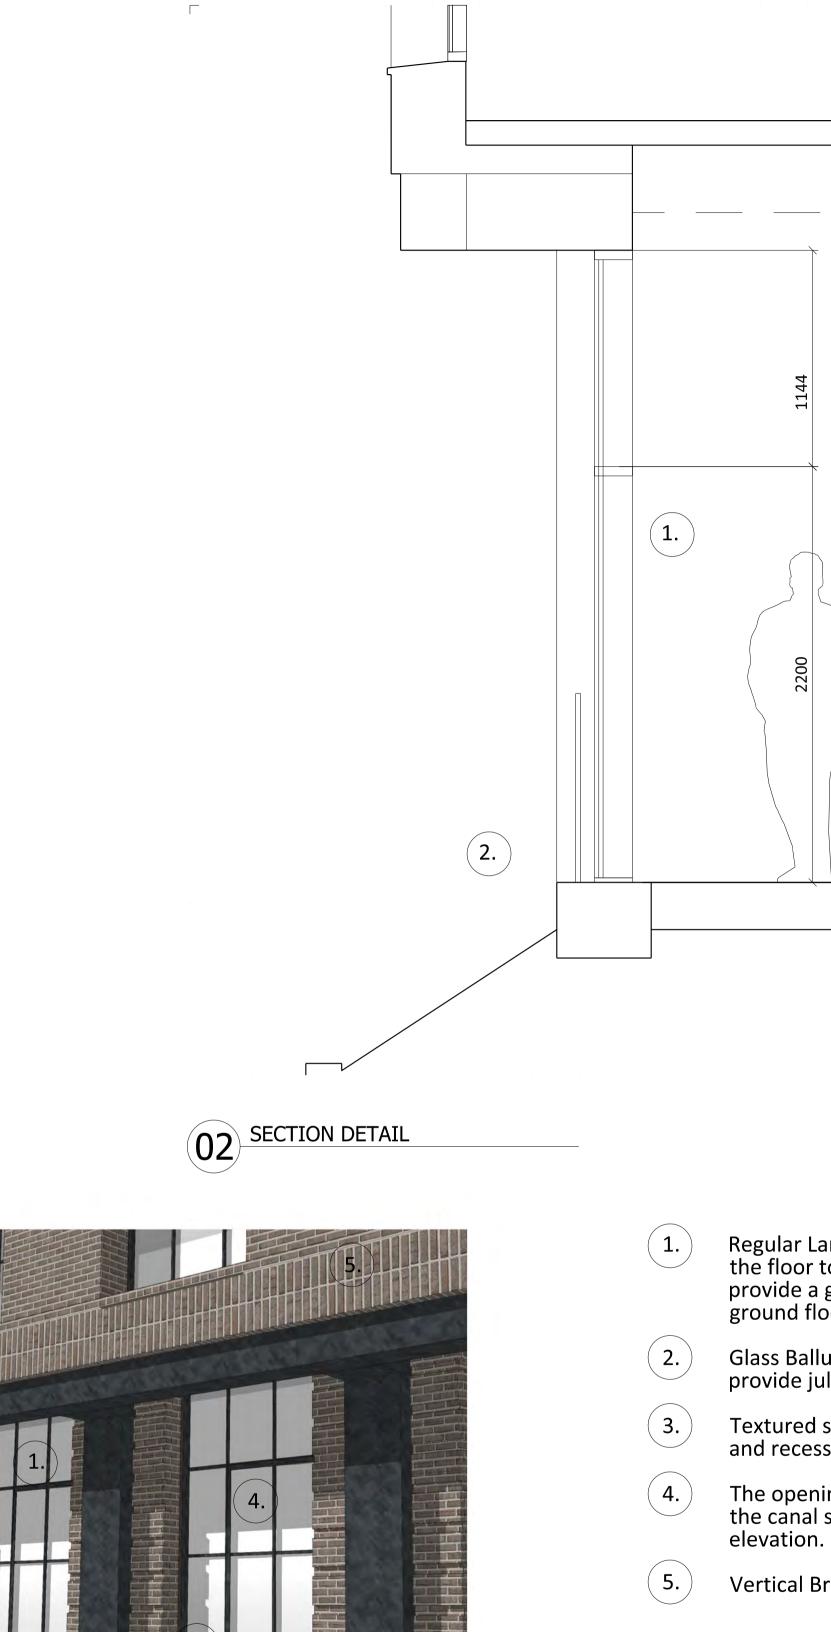
DOWS







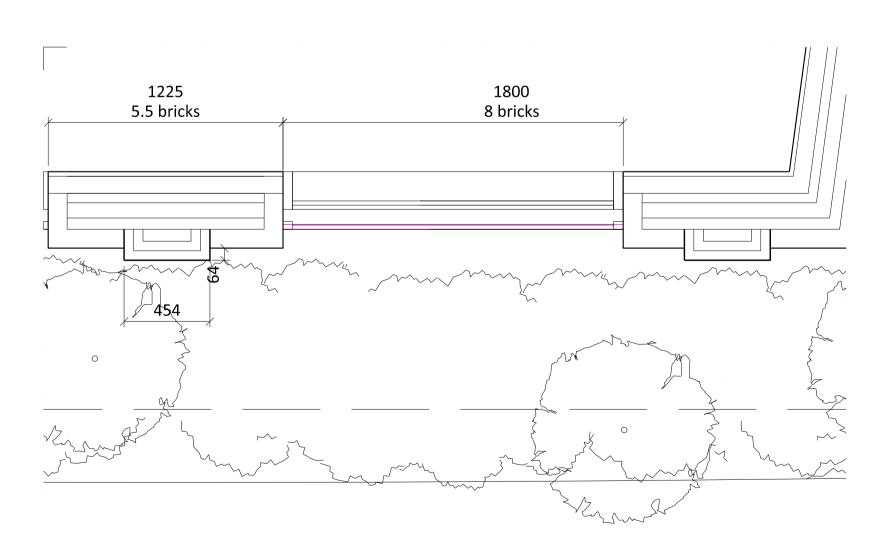



Regular Large windows have an upstand above the floor to hide internal clutter. The windows provide a good quality of north light into the ground floor office space.

- Glass Ballustrade Across Window Openings to provide juliet balcony feature
- Textured stepped brickwork with flush vertical and recessed horizontal mortar joints.
- The opening panes provide full height windows to the canal side and articulation interest to the elevation.
- Vertical Brickwork Detail

03 SKETCH DETAIL


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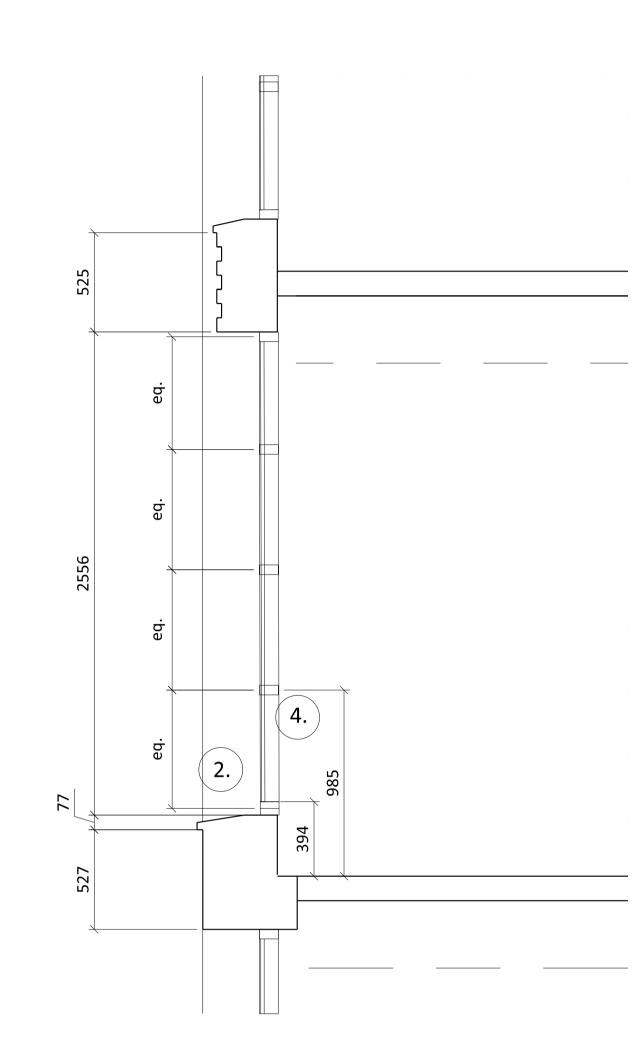
03 PLAN DETAIL

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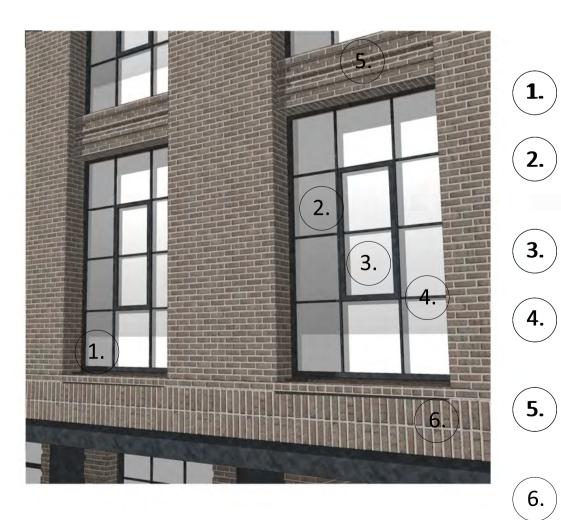
01 ELEVATION BAY STUDY DETAIL	

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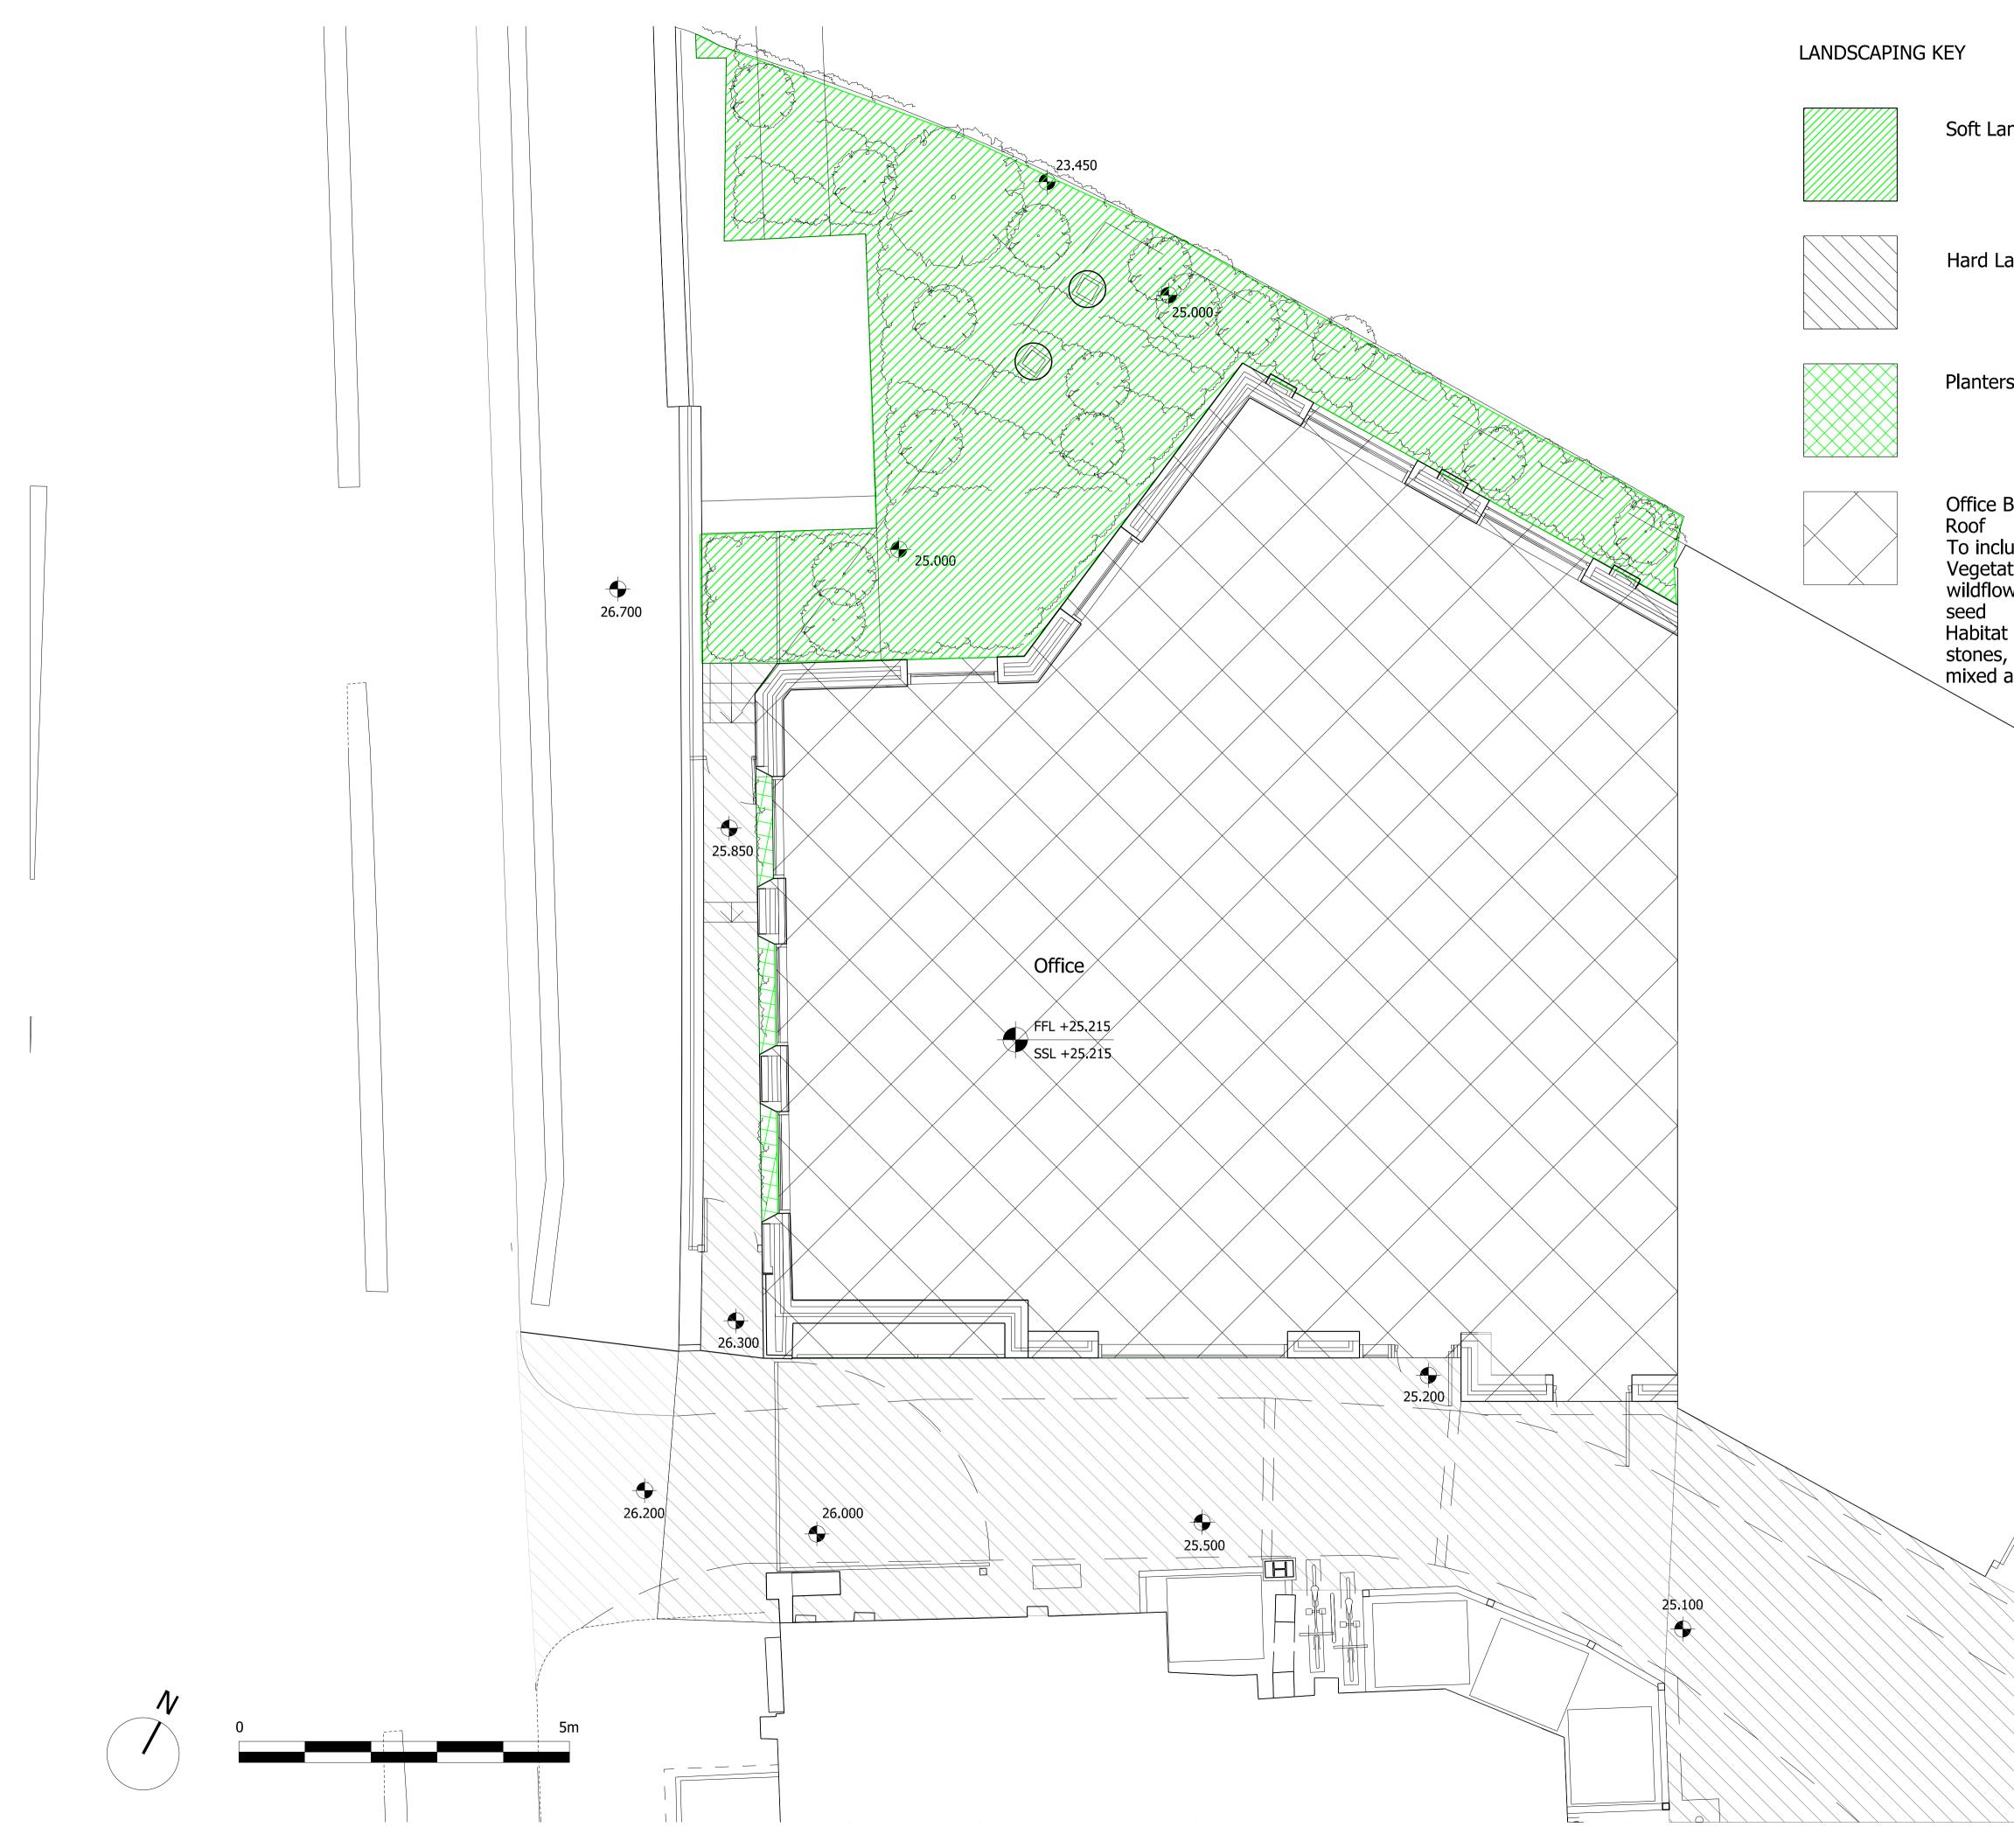




- Regular Large windows have a 365mm upstand above the floor to hide internal clutter.
- Regular framed window panes, 1.5 m by 2.4 m high, are inset the length of a brick from the face of the brick wall.
- The opening pane is set centrally, giving an articulation of interest to the elevation.
- A transom at 900 mm above FFL provides a comfortable feeling of security when the window is open.
- Textured stepped brickwork spandrel with flush vertical and recessed horizontal mortar joints. Brick sill and window head to be brick specials
- Vertical Brickwork Detail

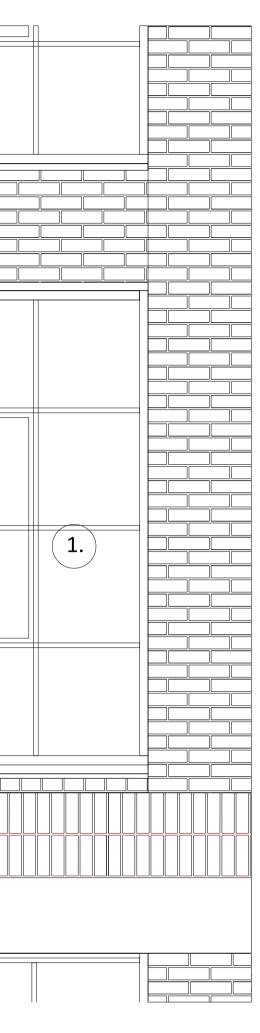NOTES DO NOT SCALE FROM THIS DRAWING. ALL DIMENSIONS TO BE CHECKED ON SITE. ALL OMISSIONS AND DISCREPANCIES TO BE REPORTED TO THE ARCHITECT IMMEDIATELY. DRAWINGS TO BE READ IN CONJUNCTION WITH ENGINEER'S DRAWINGS AND SPECIFICATION.

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